CODE ANALYSIS

	AP	PLICA	BLE CODES							
		Year				Year				
International Building Co		2006 2006			de	2005				
International Mechanica International Plumbing C		2006			ı					
International Fire Code		2006	ADA Acces							
International Energy Conservation Code		2006	Guidelines							
A. Occupancy and Grou	ıp:	<u> </u>								
Change in Use: Yes		NoX	_ Mixed Occupan	cy: Yes _	N	loX				
Special Use and Occ	upancy	(e.g. High	Rise, Covered Ma	ıll):	N/A					
B. Seismic Design Cate	gory: _	N/A	Design Wind Sp	eed: <u>N</u>	I <u>/A</u> mpl	า				
C. Type of Construction	(circle	one):								
$\frac{I}{A}$ $\frac{I}{B}$	<u>I</u>	Ī	<u>III</u> <u>III</u> I	<u> </u>	_ <u></u>	<u>Z</u>				
А В	Α '	B	A B I	HT A	E	3				
D. Fire Resistance Ratir separation distance (_	=	s for the Exterior W	/alls based	d on the	fire				
North: 0 South	n: <u> </u>	East: _	0 West:0)						
E. Mixed Occupancies:	_N0_	No	nseparated Uses:	N0_						
F: Sprinklers:										
Required:	Provid	ed: <u>X</u>	_ Type of Sprinkle	er System:	EX	ISTING				
G: Number of Stories:	_1	_ Building	Height:16'_							
H: Actual Area per Floo	or (squa	are feet): _	22000							
I: Tabular Area: N/	I: Tabular Area: N/A EXISTING									
J: Area Modifications:	J: Area Modifications: N/A									
K. Fire Resistance Rati	ng Red	luirements	for Building Eleme	nts (hours	5).					
Element	Hours	Assembly Listing	Element		Hours	Assembly Listing				
Exterior Bearing Walls	0		Floors - Ceiling Flo	ors	0					

Element	Hours	Assembly Listing	Element	Hours	Assembly Listing
Exterior Bearing Walls	0		Floors - Ceiling Floors	0	
Interior Bearing Walls	0		Roofs - Ceiling Roofs	0	
Exterior Non-Bearing Walls	0		0		
Structural Frame	0	0 Exterior Doors and Windows Shaft Enclosures	0		
Partitions - Permanent	0		0		
Fire Barriers	0		Fire Partitions	0	
	0		Smoke Partitions	0	

Exit Width Required:	_27	Exit Width Provided:	144

L. Design Occupant Load: 183

- M. Minimum Number of Required Plumbing Facilities:
 - a) Water Closets Required 1 PER ROOM Provided EXISTING b) Lavatories - Required 1 PER ROOM Provided EXISTING

 - c) Bath Tubs or Showers: 1 PER 15 PEOPLE
 - d) Drinking Fountains: 1 PER 100 PEOPLE Service Sinks: 1 PER FLOOR

FOOTNOTES:

- 1) In case of conflict with the U.S. Department of Justice Federal Registers Parts I through **Y** - ADA Guidelines and specific reference to the International Building Code Accessibility Chapters, the more restrictive requirement shall govern.
- 2) Additional Code Information shall be provided at the discretion of the Building Official for Complex Buildings. Including, but not limited to:
 - a) High Rise Requirements.
- b) Atriums.
- c) Performance Based Criteria.
- d) Means or Egress Analysis.
- e) Fire Assembly Locator Sheet.
- f) Exterior and Interior Accessibility Route.
- g) Fire Stopping, Including Tested Design Number.

UTAH STATE DEVELOPMENTAL CENTER DRYER RELOCATION DFCM# 08311410



State of Utah—Department of Administrative Services

DIVISION OF FACILITIES CONSTRUCTION AND MANAGEMENT

4110 State Office Building / Salt Lake City, Utah 84114 / 538-3018

DRAWING INDEX:


M000- TITLE SHEET

A102- RAINTREE & WILLOW CREEK ARCHITECTURAL PLANS A501- ARCHITECTURAL DETAILS & SCHEDULES M001- MECHANICAL GENERAL NOTES AND LEGEND MD101- OAKRIDGE AND QUAILRUN MECHANICAL PLAN MD102- RAINTREE AND WILLOW CREEK MECHANICAL PLAN ME101- OAKRIDGE AND QUAILRUN MECHANICAL PLAN ME102- RAINTREE AND WILLOW CREEK MECHANICAL PLAN


A101- OAKRIDGE & QUAILRUN ARCHITECTURAL PLANS

ME501- MECHANICAL DETAILS

ME601- MECHANICAL SCHEDULES

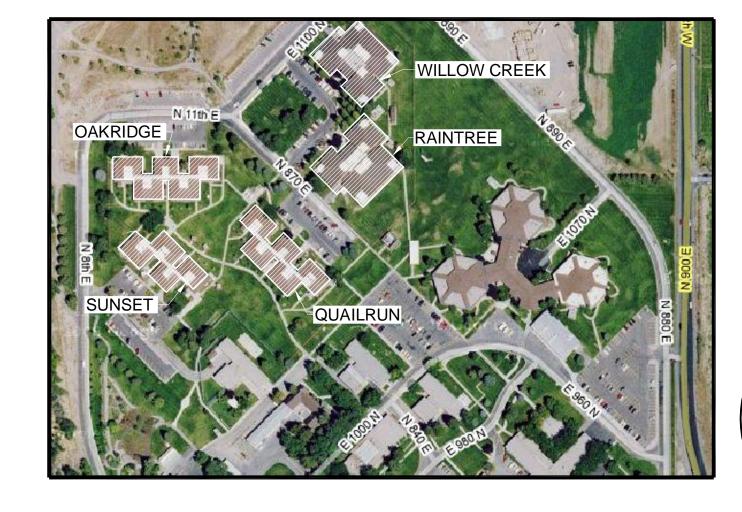


MECHANICAL ENGINEER WHW ENGINEERING, INC. 8619 SANDY PARKWAY SUITE 101 SANDY, UTAH 84075 PHONE: (801) 466-4021 FAX: (801) 466-8536

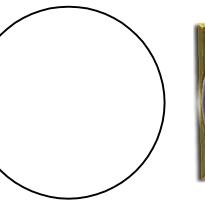





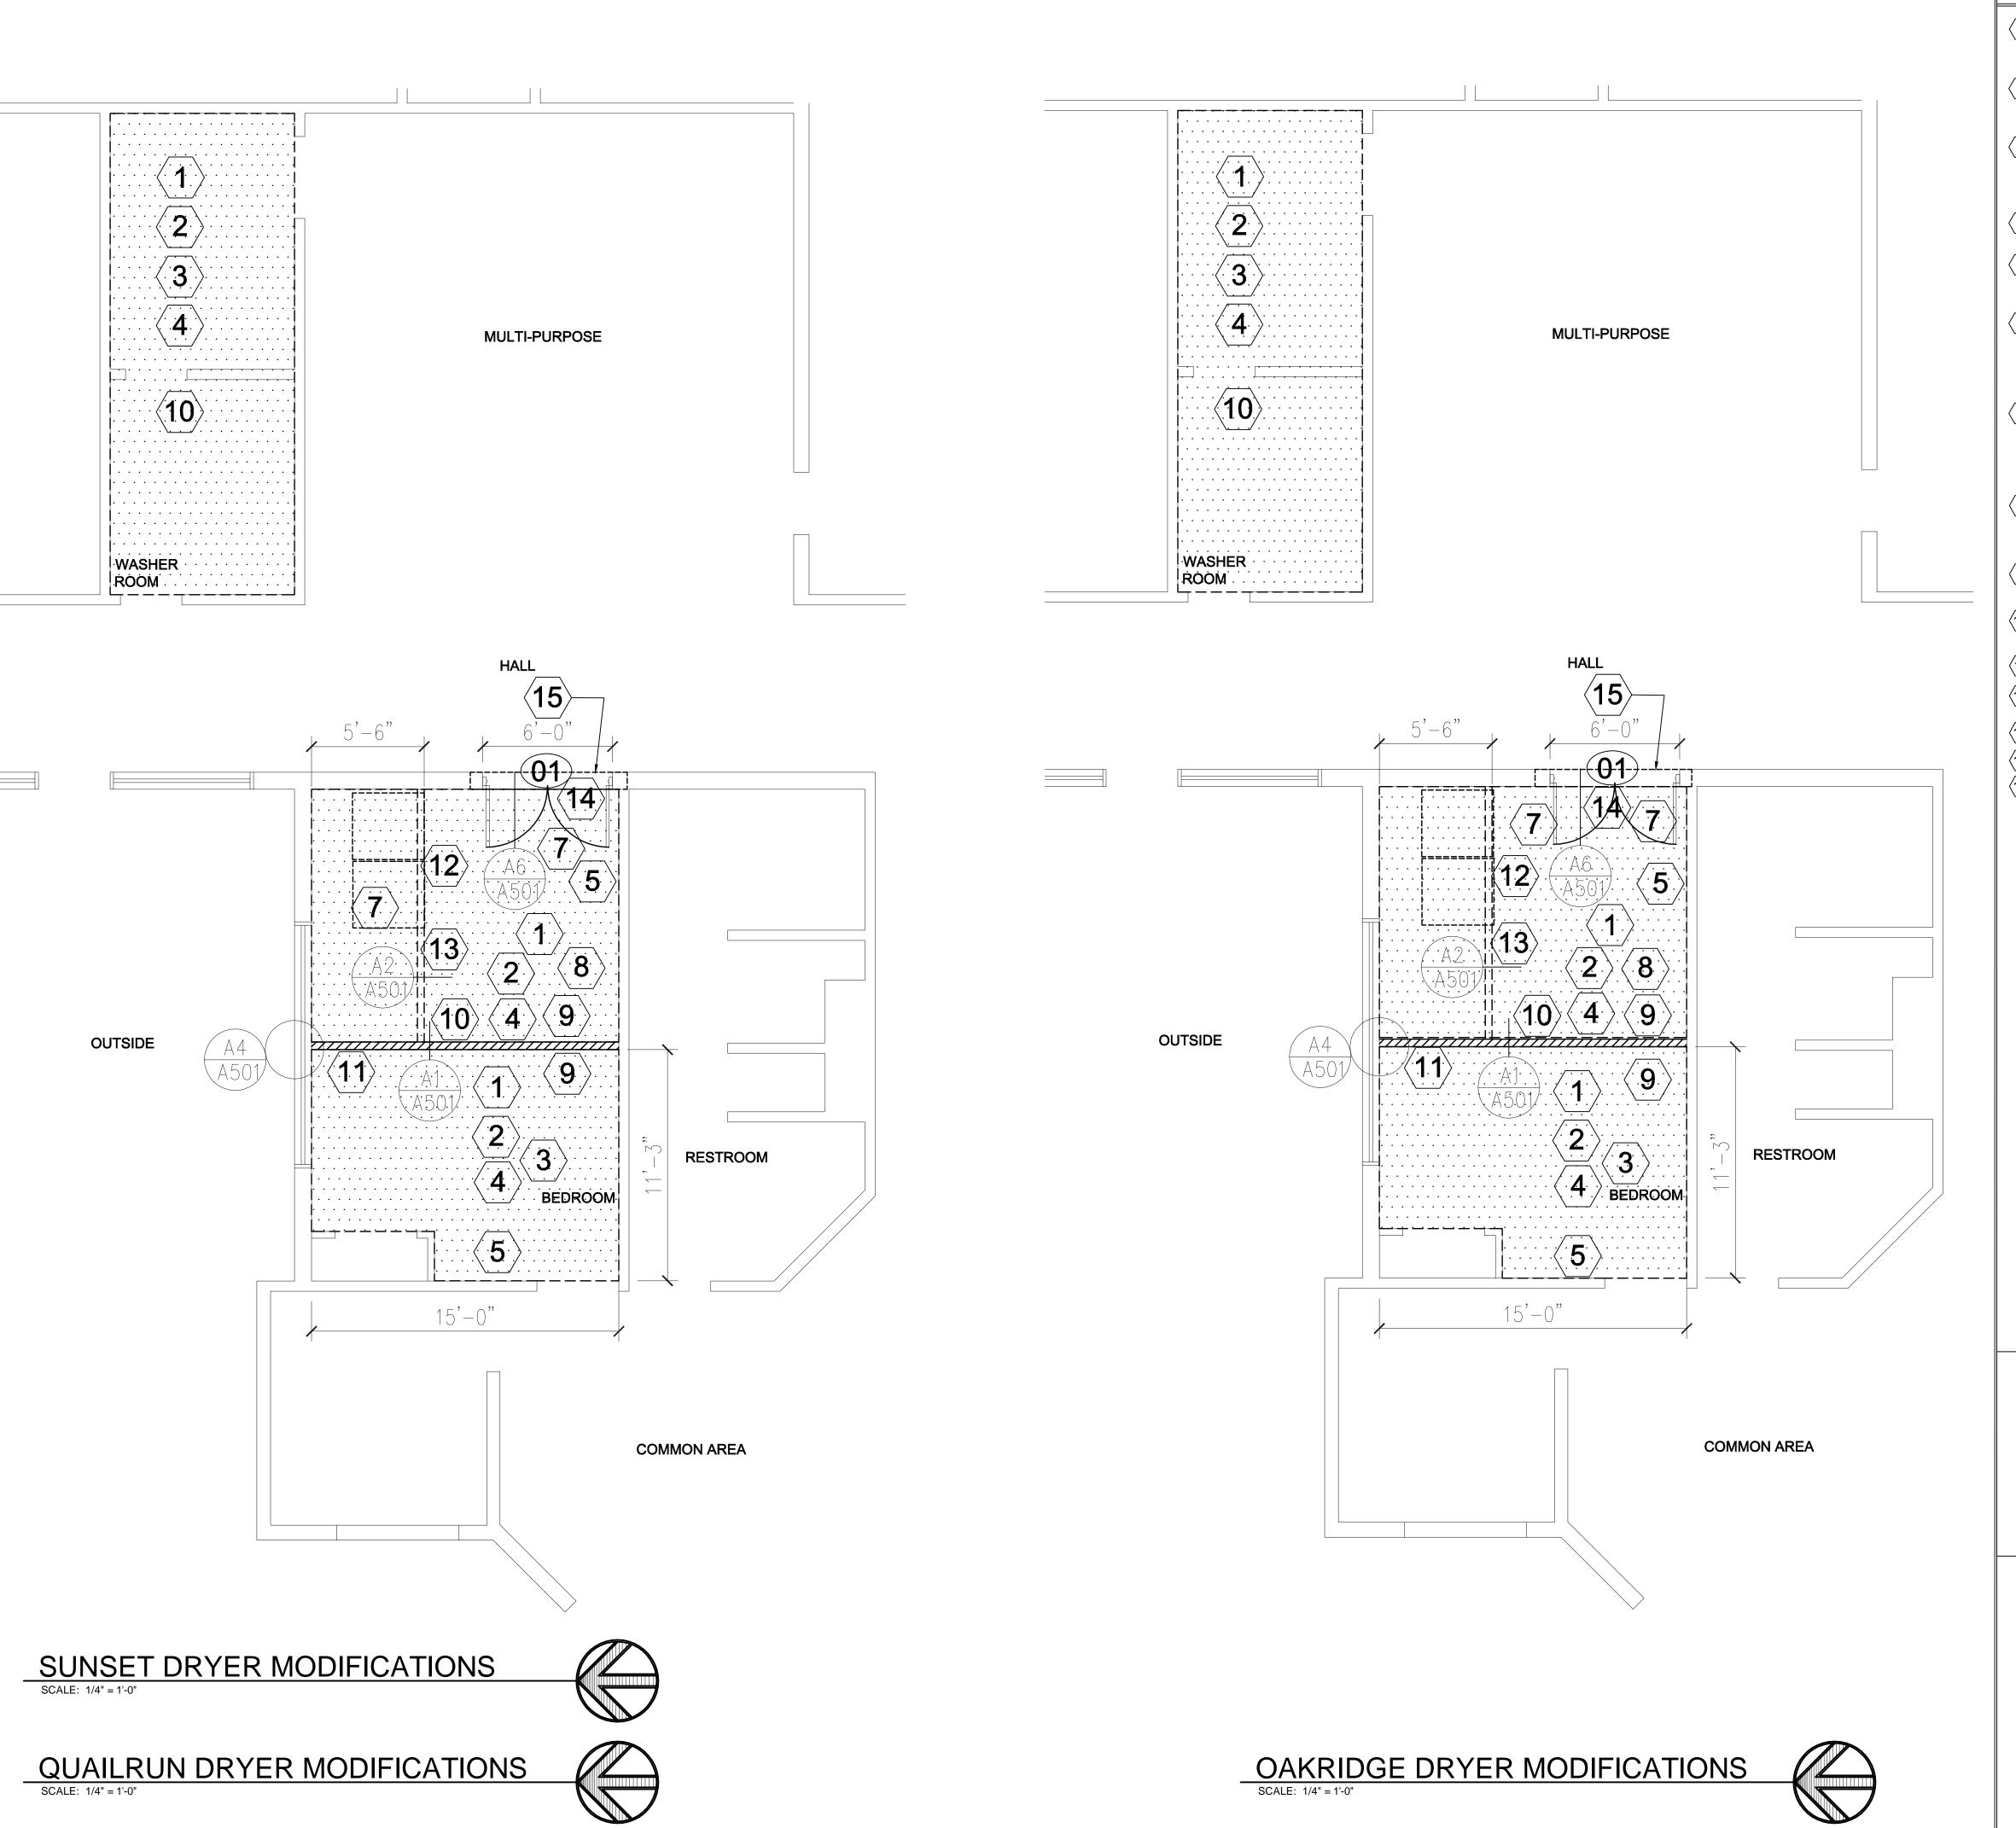

SHEET NOTES

- 1 PATCH AND REPAIR EXISTING WALLS AND CEILING DUE TO NEW CONSTRUCTION.
- 2 PAINT WALLS AND CEILING. COORDINATE COLOR WITH BUILDING TENANT.
- 3 PATCH AND REPAIR EXISTING FLOORING. COORDINATE WITH BUILDING TENANT.
- 4 REFER TO DRAWING MD101 & 102 FOR DEMOLITION.
- (5) RE-CIRCUIT EXISTING LIGHT SWITCH FOR NEW ROOM LAYOUT.
- 6 REMOVE AND DISPOSE EXISTING FLOORING AND BASE BOARD DOWN TO CONCRETE. PREP CONCRETE FLOOR FOR NEW EPOXY PAINT FINISH.
- 7 NEW ROOF PENETRATIONS FOR MECHANICAL EQUIPMENT: PROVIDE FLASHING AT CURBS PER ROOF MANUFACTURERS STANDARD DETAILS TO MAINTAIN WARRANTY OF EXISTING ROOF SYSTEM.
- 8 PROVIDE EPOXY PAINT FLOORING COORDINATE WITH BUILDING TENANT FOR COLOR AND FINISH.
- 9 PROVIDE NEW RUBBER BASE BOARD TO MATCH EXISTING SIZE, STYLE AND COLOR.
- (10) SHADED AREA INDICATE AREA OF CONSTRUCTION .
- (11) CENTER NEW WALL ON WINDOW MULLION
- (12) NEW DRYERS REFER TO MECHANICAL DRAWINGS.
- (13) LINE OF CEILING DROP ABOVE.

GENERAL NOTE:

THIS PAGE CONSISTS OF 2 AREAS

REFER TO DRAWING ME101 FOR

ARCHITECT

2 PEPPERWOOD POINTE

SANDY, UTAH 84092 OFFICE: (801) 572-1997 CELL: (801) 647-8043 FAX: (801) 572-9103

IN 3 SEPARATE BUILDINGS.

BUILDING KEY PLAN.

- 14 STEEL LINTEL AT NEW MASONRY OPENING
- (15) SAW CUT OPENING IN MASONRY WALL FOR NEW DOOR. REMOVE AND DISPOSE OF MATERIAL. RELOCATE ANY ELECTRICAL DEVICES & CONDUIT THAT MAY BE IN THE WAY.



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PROJECT NAME & ADDRESS

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UTAH STATE
DEVELOPMENT
CENTER DRYER
RELOCATION
DFCM# 08311410

AMERICAN FORK, UTAH

MARK DATE REVISION

PROJECT MANAGER:
SLW

DRAWN BY:
FLT

CHECKED BY:
FLT


DATE:

12/12/08
WHW JOB NO.:
06039
SHEET TITLE

OAKRIDGE AND QUAILRUN ARCHITECTURAL PLAN

SHEET NO.

A101

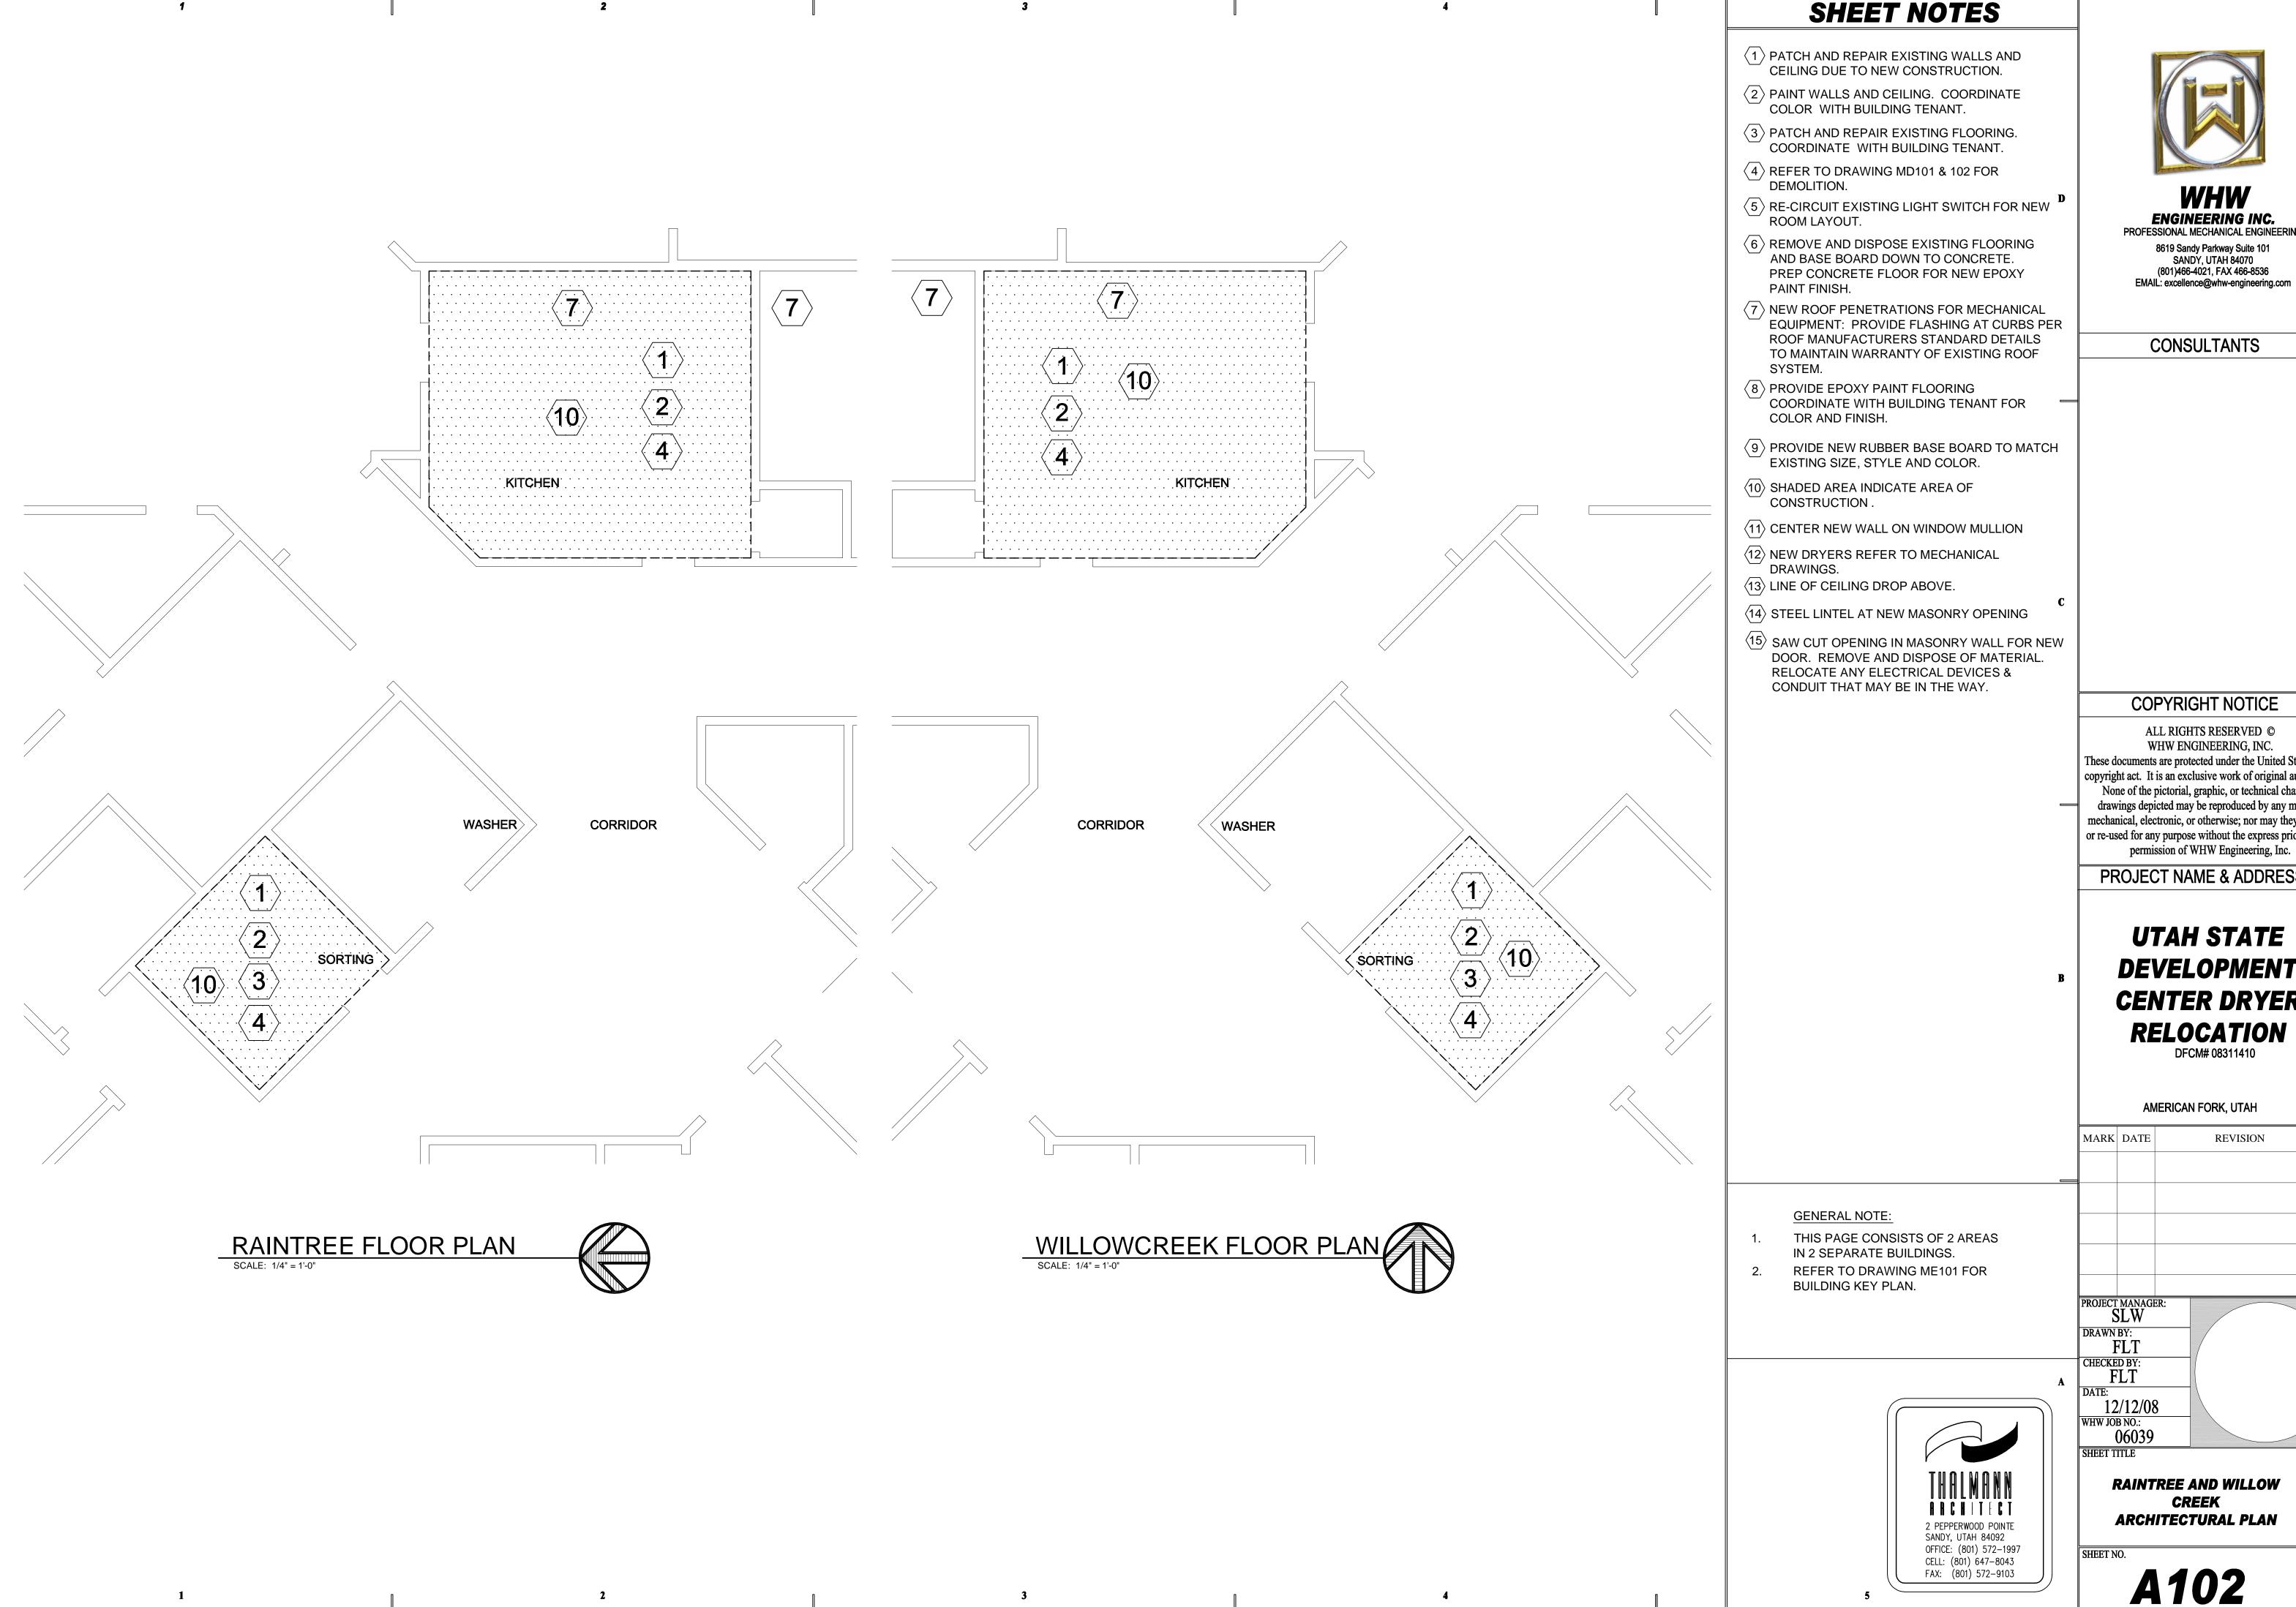




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PROJECT NAME & ADDRESS

UTAH STATE DEVELOPMENT CENTER DRYER RELOCATION

RAINTREE AND WILLOW



BOMMER

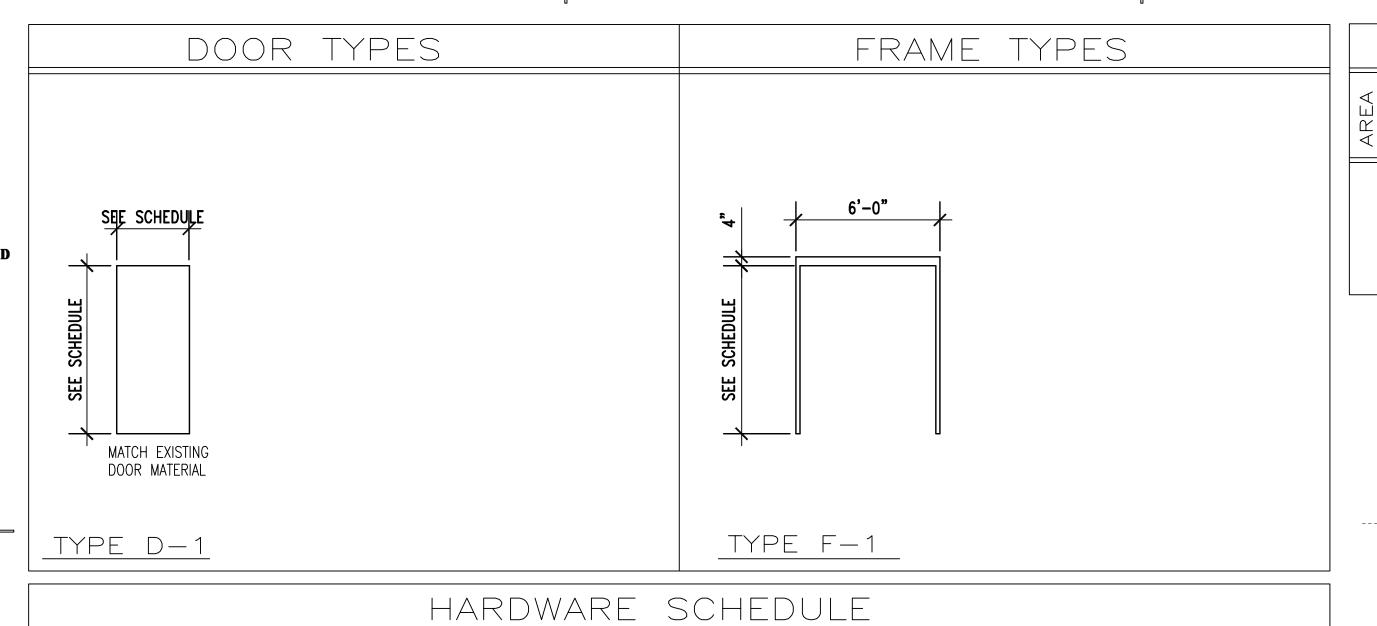QUALITY

LCN QUALITY

626

2

3

(A3)

SCALE: NONE

1

COORDINATE WITH USDC STANDARD FOR HARDWARE MFR, STYLE, FINISH AND KEYING.

P4041 EDA 307

BB5000 4.5 X 4.5

L-SERIES ND50PD RHO 626 1358-12" 626

HARDWARE GROUP 1

EACH

EACH EACH

EACH

PAIR BUTTS

LOCKSET

CLOSER

STOP

FLUSH BOLTS

	DOOR SCHEDULE																	
EA	NO.	DOC	R SIZ	ZE	DOOR	DOOR	DOOR		ENING				FRAME	FRAME	RATING	HRDW.	REMARKS	NO.
A R		WIDTH	HEIGHT	тніск.	TYPE	MAT.	FINISH	HEAD	RIGHT JAMB	LEFT JAMB	SILL THRES	TYPE	MAT.	FINISH	RATING	GROUP	INCIVIATORS	
	(1)	2'-10"	7'-0"	1 3/4"	D-1	SC WD	STAIN	A3/A501	A3/A501	A3/A501		F-1	HOL. MTL.	PAINT	60 MIN	1	PAIR OF DOORS	01)

USE TYPE 'X' GYPSUM BOARD AT ALL FIRE RATED


SEE DOOR SCHEDULE FOR SIZE AND MATERIAL - SEE PLAN FOR DOOR


ASSEMBLIES


SWING AND LOCATION

WALL JAMB /HEAD DETAIL

- HOLLOW METAL DOOR FRAME

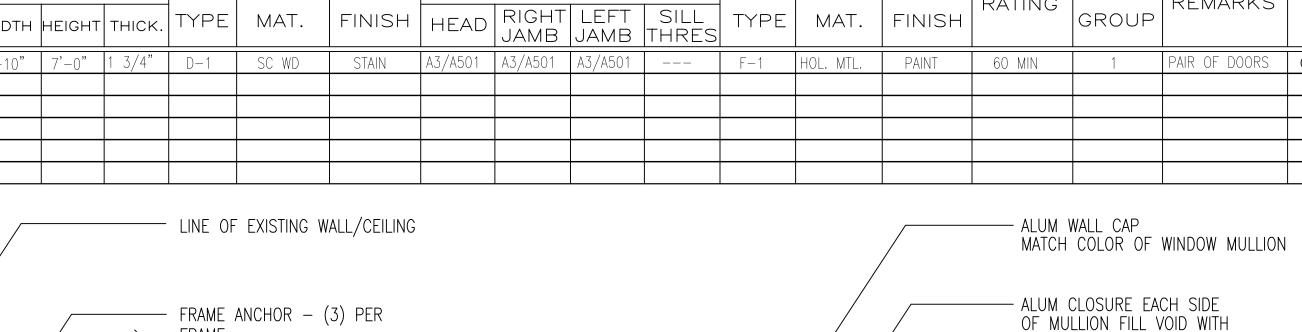

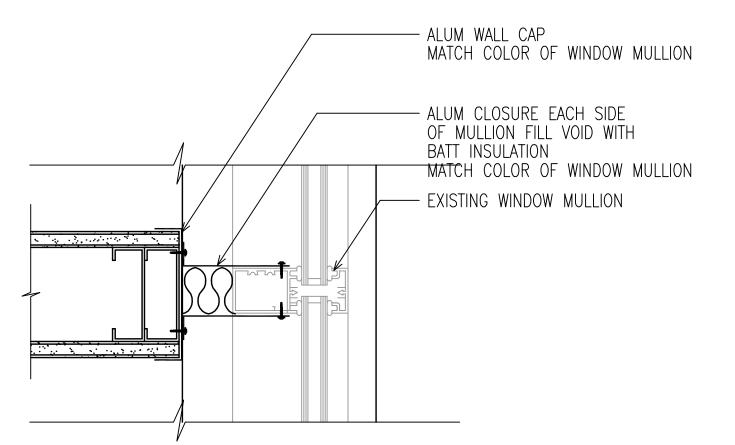

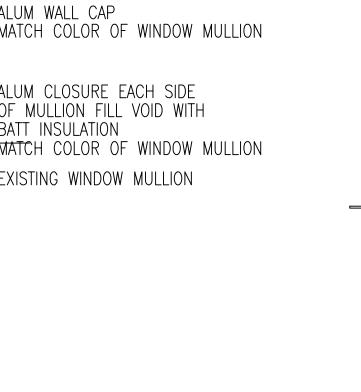

6. INSTALL REMAINING ANGLES AND

PLATES.


PROCEDURE FOR MAKING DOOR OPENING.


SCALE: NONE

WALL AT WINDOW DETAIL (A4)SCALE: NONE

- EXISTING MASONRY WALL

-NEW(2)-L 5 X 3 1/2 X 5/16W/(3)-3/4"ø THRU BOLTS. 1 BOLT AT CENTER LINE OF SPAN EXTEND ANGLES 8" BEYOND OPENING. GROUT CELLS SOLID BELOW BEARING. AFTER INSTALLATION, BOLTS MAY BE WELDED TO ANGLES AND GROUND SMOOTH. ; h 11 h 11 h 11 f -3/16" X DIM. REQ'D X CONT. BOTTOM PLATE. "DIM" IS WIDTH OF WALL LESS 2". 3/16 / 208 -SAW CUT ONE SIDE OF WALL & PLACE ANGLE ON ONE SIDE BEFORE REMOVING MASONRY BELOW. THEN INSTALL OTHER

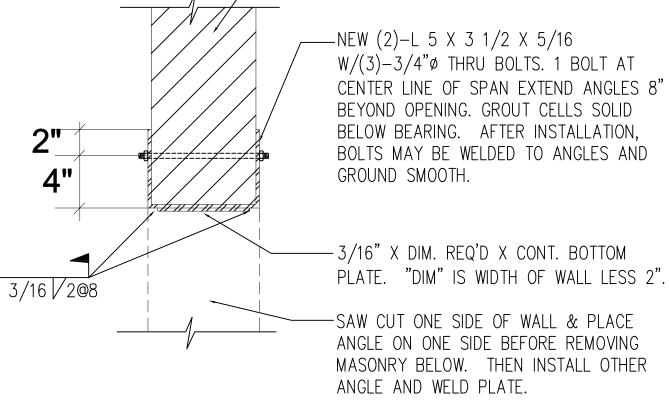

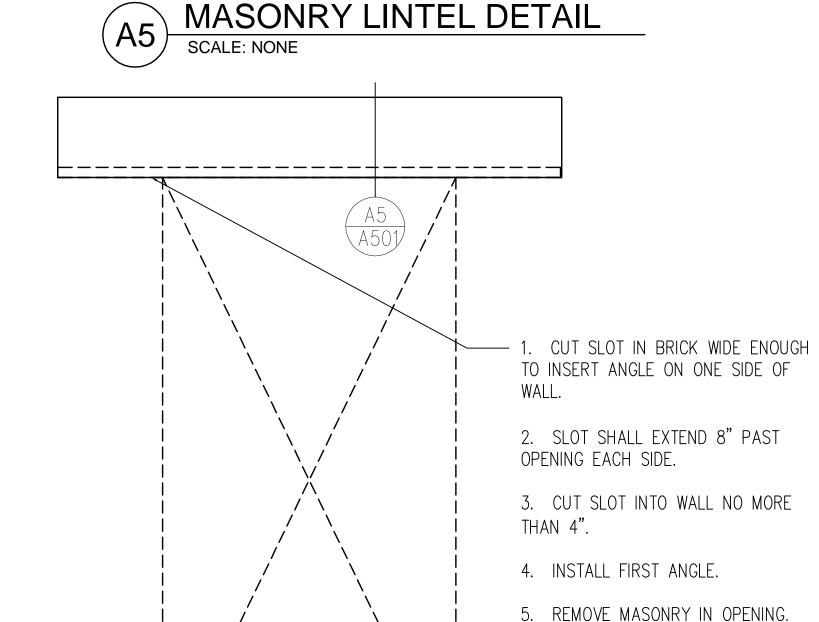

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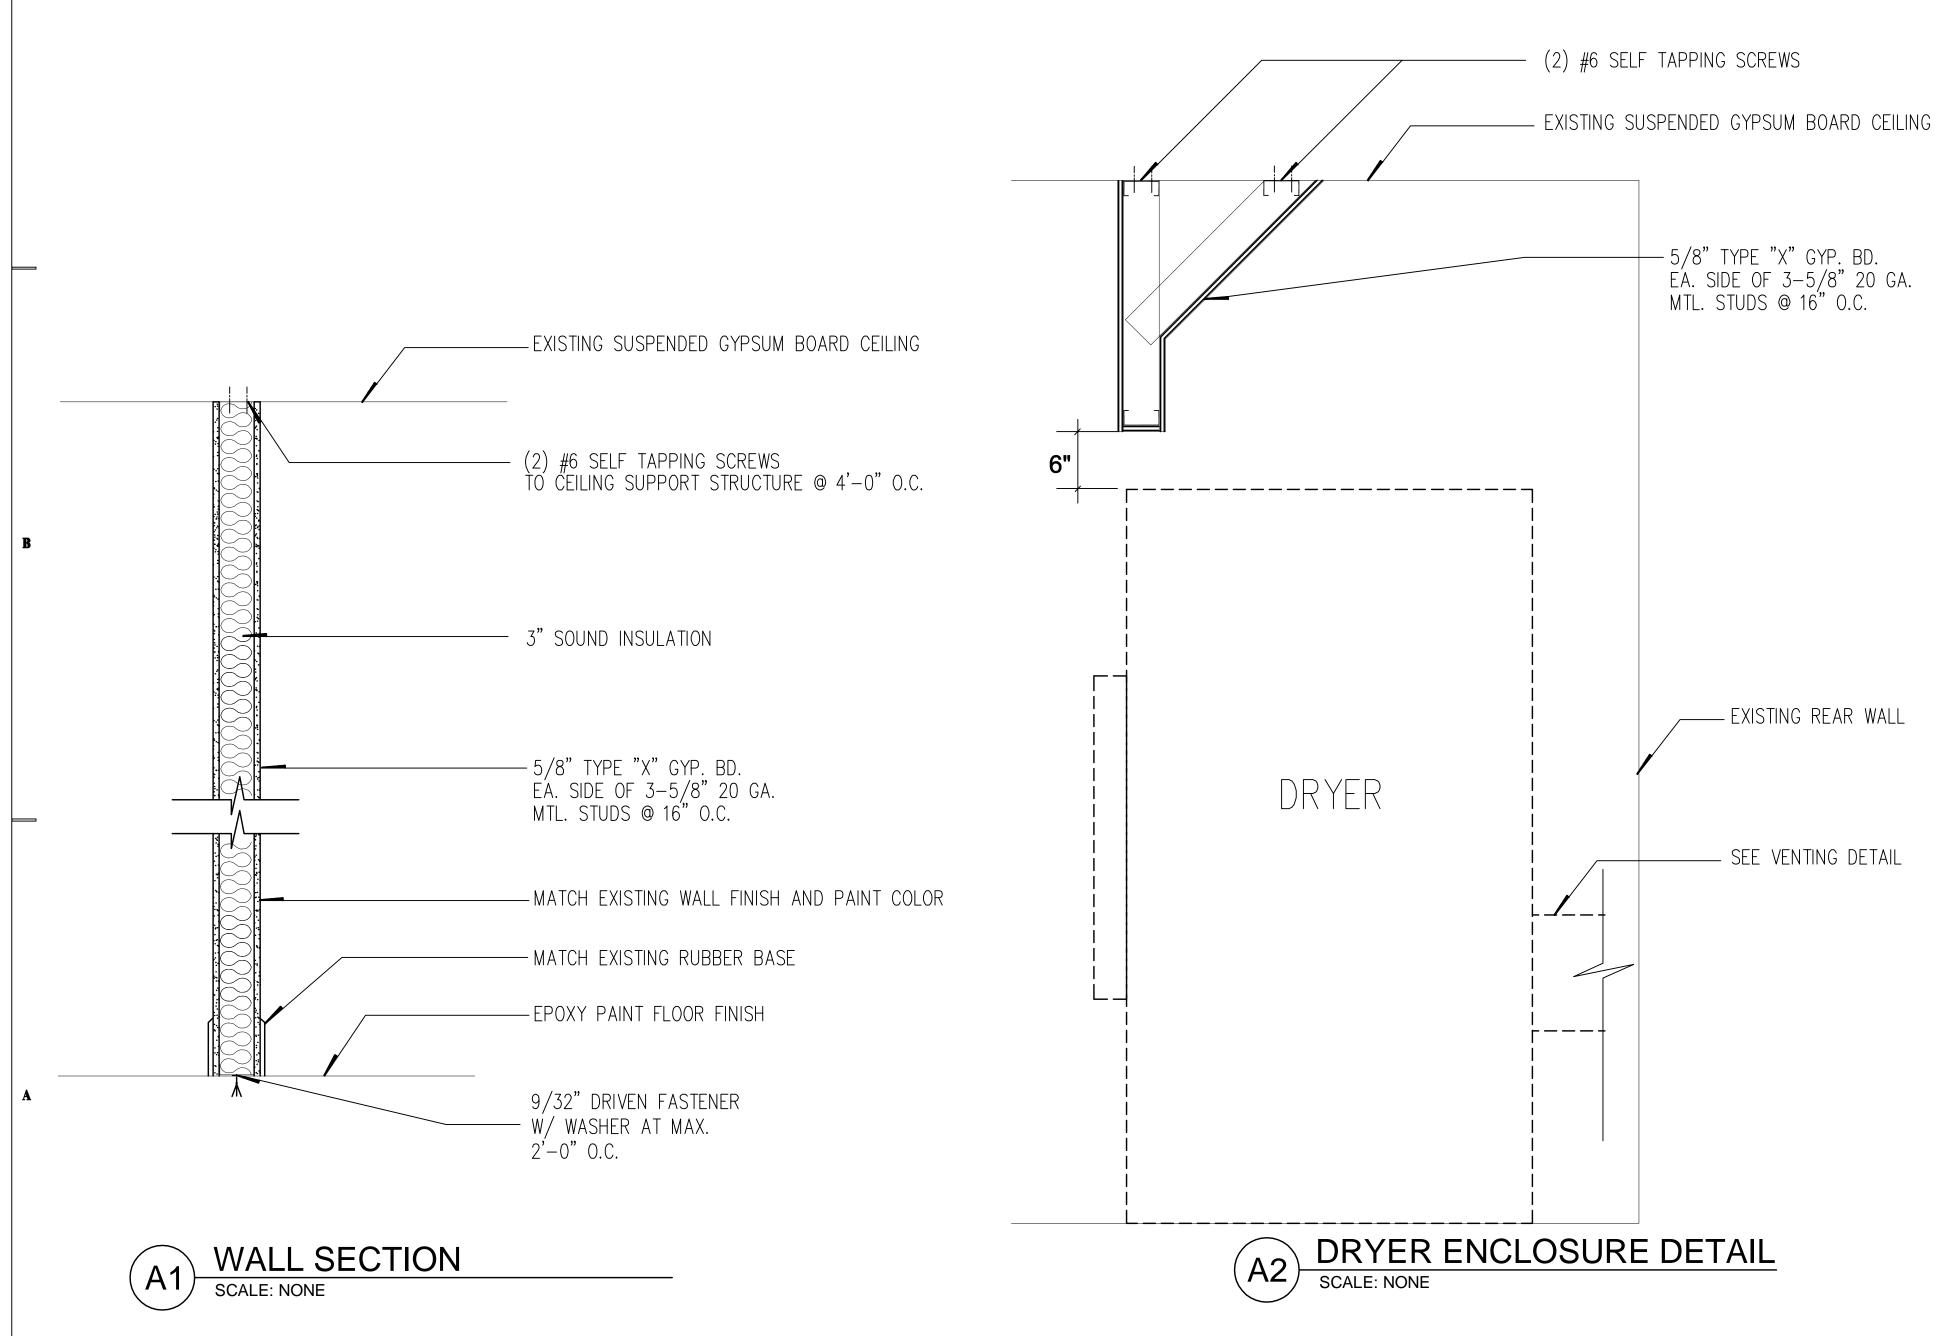
UTAH STATE **DEVELOPMENT CENTER DRYER** RELOCATION DFCM# 08311410

AMERICAN FORK, UTAH

MARK DA	ATE	REVISION
PROJECT MA SLV	NAGER: W	
DRAWN BY: FL'		
CHECKED B' FL7	Y:	
DATE: 12/12		
WHW JOB NO).: 039	
SHEET TITLE	3	

DETAILS & SCHEDULES

A501



SCHLAGE (WITH "BEST CORE" COORDINATE WITH USDC STANDARD).

					MECHANICA	\overline{AL}
SYMBOL	ABR.	DESCRIPTION	SYMBOL	ABR.	DESCRIPTION	SYM
	•	GENERAL TERMINOLOGY			AIR SIDE	
A		SECTION LETTER DESIGNATION	⊬⊣ ŧ∃		EXISTING AIR DUCT TO BE REMOVED	
ME-101		SECTION DRAWN ON THIS SHEET	├ ├ ├ ├		EXISTING AIR DUCT TO REMAIN	
42		DETAIL NUMBER DESIGNATION	₩₩		NEW AIR DUCT	
A2)		CORRESPONDING WITH GRID LOCATION	江草		RECT. TO RECT. AIR DUCT TAKE-OFF	
AH		MECHANICAL EQUIPMENT DESIGNATION	江 营		RECT. TO RND. AIR DUCT TAKE-OFF	
1		EQUIPMENT ITEM DESIGNATION	江草		RND. TO RND. AIR DUCT TAKE-OFF	
D-1		REGISTER, GRILL OR DIFFUSER DESIGNATION WITH BALANCING CFM LISTED	1 1 1 1 1 1 1 1 1 1		RECT. TAKE-OFF AT END OF MAIN	
CFM		BELOW BELOW			LINED DUCT	
R-1		GRILLE, OR LOUVER DESIGNATION WHERE			VANED ELBOW	ى كى
K-1		BALANCING NOT REQUIRE	7 4		RADIUS ELBOW	
À		REVISION DESIGNATOR AND NUMBER	M DI		CONCENTRIC DUCT TRANSITION	
1		KEY NOTE DESIGNATOR AND NUMBER	₩ □		ECCENTRIC DUCT TRANSITION	—(
•	POC	POINT OF CONNECTION	₩ VD E		VOLUME DAMPER	
•	POR	POINT OF REMOVAL	\boxtimes		SUPPLY AIR DIFFUSER	
AFF		ABOVE FINISHED FLOOR			RETURN AIR, FRESH AIR	
AP		ACCESS PANEL			EXHAUST GRILLE	
ĢEL.		CENTER LINE ELEVATION			RETURN OR OUTSIDE AIR DUCT UP	
GC		GENERAL CONTRACTOR			SUPPLY DUCT UP	
MC		MECHANICAL CONTRACTOR			EXHAUST AIR INTAKE UP	
CC		CONTROL CONTRACTOR			RETURN OR OUTSIDE AIR DUCT DOWN	
EC		ELECTRICAL CONTRACTOR			SUPPLY DUCT DOWN	
NIC		NOT IN CONTRACT			EXHAUST DUCT DOWN	
NTS		NOT TO SCALE	├७ !! ®		ROUND DUCT UP	
			田		ROUND DUCT DOWN	
					FLEXIBLE DUCT CONNECTION	
					EXISTING EQUIPMENT TO BE REMOVED	
					EXISTING EQUIPMENT TO REMAIN	
					NEW EQUIPMENT	
			SA		SUPPLY AIR	
			RA		RETURN AIR	
			EA		EXHAUST AIR	

LEGEND

UNION

BV BALL VALVE

STRAINER

DESCRIPTION

WET SIDE

MANUAL ACTUATOR (BALL,

MOTORIZED CONTROL

PRV PRESSURE RELIEF VALVE

MANUAL AIR VENT

DIRECTION OF FLOW

BUCKET TRAP

BUTTERFLY, NEEDLE, ETC. VALVES)

STRAINER W/ PLUGGED BLOW OFF

PRESSURE GAUGE AND GAUGE COCK -

FLOAT & THERMOSTATIC STEAM TRAP

SYMBOL ABR.

--0--

-DR—

-LPR-

-MPS-

 $\mathsf{-MPR}\mathsf{--}$

DESCRIPTION

EXISTING PIPING TO BE REMOVED

EXISTING PIPING TO REMAIN

WET SIDE CONT

PITCH DOWN

ELBOW DOWN

ELBOW UP

TEE DOWN

NEW PIPING

PIPE CAP OR PLUG

| CW | CULINARY COLD WATER

HW | CULINARY HOT WATER

EQUIPMENT DRAIN

LOW PRESSURE STEAM

LOW PRESSURE STEAM RETURN

MEDIUM PRESSURE STEAM RETURN

MEDIUM PRESSURE STEAM

CONCENTRIC REDUCER

ECCENTRIC REDUCER

GENERAL NOTES:

G-1 MECHANICAL INFORMATION IS NOT LIMITED TO THE MECHANICAL DRAWINGS. CONTRACTOR SHALL BE RESPONSIBLE FOR INFORMATION ON ALL OTHER CONSTRUCTION DISCIPLINES.

A - EACH DRAWING SHEET AND THE SPECIFICATIONS HAVE BEEN PREPARED TO SUPPLEMENT EACH OTHER AND THEY SHALL BE INTERPRETED AS AN INTEGRAL UNIT WITH ITEMS SHOWN AND NOTED ON ONE AND NOT THE OTHER BEING FURNISHED AND INSTALLED AS THOUGH SHOWN AND CALLED OUT IN ALL PLACES. ITEMS IN SPECIFICATIONS OR DRAWINGS LISTED WHICH ARE DIFFERING IN EFFICIENCY OR QUALITY SHALL BE HELD TO THE GREATEST OF: EFFICIENCY, QUALITY OR GOVERNING CODE.

B - THE CONTRACTOR WILL BE HELD RESPONSIBLE FOR THE INSTALLATION OF THE SYSTEMS ACCORDING TO THE TRUE INTENT AND MEANING OF THE CONTRACT DOCUMENTS.

C - THE CONTRACTOR SHALL INSTALL ALL EQUIPMENT WITH PROPER SERVICE ACCESS AND CLEARANCES ACCORDING TO MANUFACTURERS RECOMMENDATIONS. THE CONTRACTOR SHALL REVIEW SUPPLIERS BID PACKAGES FOR COMPLETENESS AND COMPLIANCE TO THE SPECIFICATIONS, SCHEDULES, AND DESIGN INTENT (ALL EQUIPMENT AND METHODS). THE CONTRACTOR SHALL REMOVE AND REINSTALL CORRECTLY AT HIS OWN EXPENSE ANY EQUIPMENT NOT IN COMPLIANCE.

D - THE CONTRACTOR SHALL CONSULT MANUFACTURERS INSTALLATION INSTRUCTIONS FOR SIZES, METHODS, ACCESSORIES, AND CLEARANCES IN SPACE AVAILABLE PRIOR TO BIDDING PROJECT.

E - ANYTHING NOT CLEAR OR IN CONFLICT WILL BE EXPLAINED BY MAKING APPLICATION TO THE ENGINEER IN WRITING.

- G-2 ANY AND ALL ALTERATIONS TO THE SYSTEM SHOWN SHALL BE SUBMITTED TO THE ENGINEER FOR APPROVAL. CONTRACTOR SHALL NOT PERFORM ANY ALTERATIONS UNTIL APPROVED BY ENGINEER.
- G-3 CONTRACTOR SHALL FIELD VERIFY ALL DIMENSIONS AND LOCATIONS.
- G-4
 THE WORKING DRAWINGS ARE DIAGRAMMATIC. THEY DO NOT SHOW EVERY OFFSET, BEND, OR ELBOW NECESSARY FOR THE COMPLETE INSTALLATION IN THE SPACE PROVIDED. ALL LOCATIONS FOR MECHANICAL EQUIPMENT SHALL BE FIELD VERIFIED AND COORDINATED WITH ALL DRAWINGS. THE CONTRACTOR SHALL PROVIDE OR COORDINATE WITH THE GENERAL CONTRACTOR PROVISIONS FOR BLOCKOUTS OR CORE DRILLS THROUGH STRUCTURE.
- G-5 THE INSTRUCTION TO "PROVIDE" ALSO INCLUDES INSTALLATION.
- G-6 SHEET METAL DUCT SIZES SHOWN ON DRAWINGS ARE FREE AREA DIMENSIONS.
- G-7 PROVIDE AND INSTALL BALANCING DAMPERS IN ALL SUPPLY AND EXHAUST AIR BRANCH DUCTS. BALANCE TO CFM SHOWN ON PLAN.
- G-8 PROVIDE TURNING VANES IN ALL ELBOWS OF RECTANGULAR DUCT.
- G-9 THE MECHANICAL CONTRACTOR SHALL VERIFY MOTOR VOLTAGES BEFORE ORDERING MOTORIZED EQUIPMENT AND CONTROLS.
- G-10 C.F.M. LISTED IS ACTUAL AIR.
- G-11
 SUPPLIERS SHALL REVIEW ALL DRAWINGS AND THE SPECIFICATIONS
 PRIOR TO SUBMITTING PRICES TO THE CONTRACTOR. ALL QUESTIONS
 AND DISCREPANCIES SHALL BE BROUGHT TO THE ENGINEERS
 ATTENTION PRIOR TO BIDDING.
- G-12
 CONTRACTOR SHALL THOROUGHLY REVIEW AND SIGN SUBMITTALS FOR COMPLETENESS AND COMPLIANCE TO THE SPECIFICATIONS PRIOR TO ENGINEERS REVIEW. SUPPLIERS SHALL HIGHLIGHT OR MARK ALL INFORMATION REQUIRED TO SHOW COMPLIANCE TO THE SPECIFICATIONS. ALL REQUESTED EXCEPTIONS TO THE SPECIFICATIONS, OR SCHEDULES SHALL BE CLEARLY NOTED AND EXPLAINED. SUBMITTAL REVIEW AND ACCEPTANCE IS FOR DESIGN CONCEPT ONLY, AND DOES NOT AT ANY TIME RELIEVE THE CONTRACTOR OF RESPONSIBILITY TO MEET SPECIFICATIONS, CAPACITIES. OR DESIGN INTENT.
- G-13 ALL MECHANICAL SHALL BE INSTALLED AND CONFORM TO THE 2006 EDITION OF THE IMC AND IPC WITH UTAH ANNOTATIONS AND LOCAL AUTHORITY REQUIREMENTS.
- G-14

 MECHANICAL CONTRACTOR SHALL SUB-CONTRACT THE ELECTRICAL PORTION OF THIS CONTRACT TO A DESIGN-BUILD ELECTRICAL CONTRACTOR. ELECTRICAL CONTRACTOR SHALL FOLLOW SPECIFICATION AND INSTALL THE ELECTRICAL PER NEC. ELECTRICAL DESIGN -BUILD CONTRACTOR SHALL MEET WITH THE ENGINEER PRIOR TO ANY ELECTRICAL INSTALLATION FOR APPROVAL OF CONTRACTORS DESIGN INTENT.



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PROJECT NAME & ADDRESS

UTAH STATE
DEVELOPMENT
CENTER DRYER
RELOCATION

DFCM# 08311410

AMERICAN FORK, UTAH

REVISION


MARK DATE

PROJECT MANAGER: SLW	
DRAWN BY: STAFF	
CHECKED BY: SLW	
DATE:	
12/12/08	
whw јов no.: 06039	
SHEET TITLE	

MECHANICAL GENERAL NOTES AND LEGEND

SHEET NO

M001

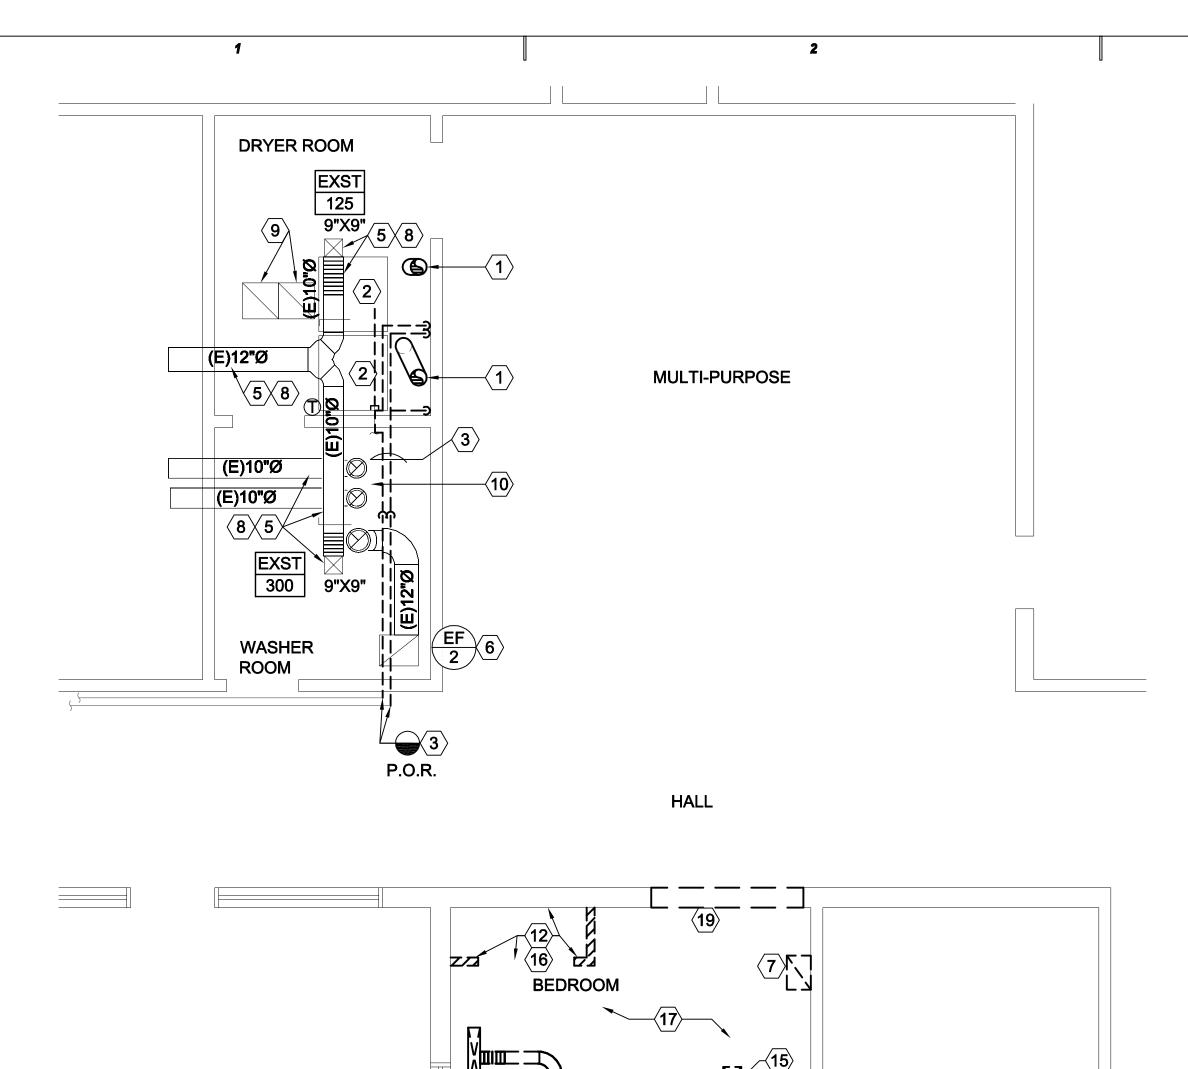


P.O.R. | |

(E)6"Ø

(E)14"Ø EXISTING

RESTROOM

P.O.R. 15

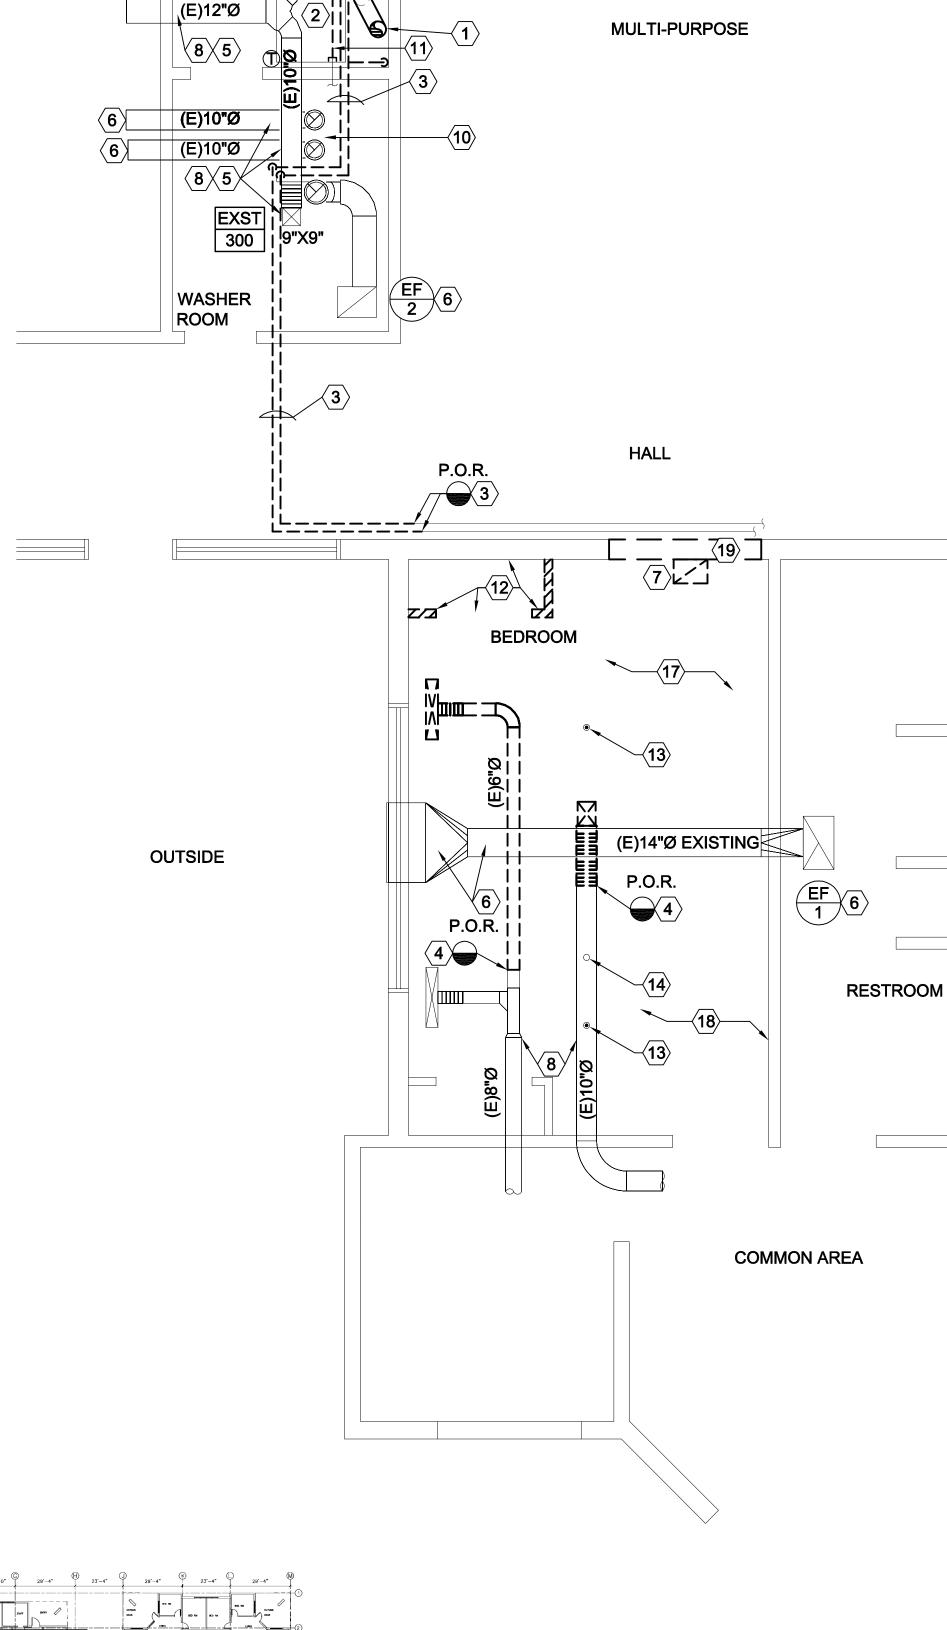

3

DRYER ROOM

SHEET NOTES

- REMOVE EXISTING DRYER VENTS TO A POINT JUST UNDER ROOF. VENT PIPING AND PENETRATION THRU ROOF SHALL REMAIN. CAP VENT BELOW AND ABOVE ROOF.
- REMOVE EXISTING DRYERS AND RELOCATE TO NEW LOCATION SHOWN ON SHEET ME101. DISASSEMBLE AS REQUIRED TO FIT THRU DOORS.
- REMOVE EXISTING STEAM AND CONDENSATE PIPING VALVES ETC. SERVING EXISTING DRYERS BACK TO THIS POINT. FIELD VERIFY LOCATION.
- REMOVE EXISTING DUCTWORK BACK TO THIS LOCATION. SEE SHEET ME101 FOR RECONNECTION. FIELD VERIFY.
- (5) EXISTING DUCTWORK, DIFFUSERS, AND GRILLES SHALL REMAIN.
- 6 EXISTING EXHAUST FAN AND DUCTWORK SHALL REMAIN.
- 7 REMOVE EXISTING R.A. CEILING GRILLE.
- (8) EXISTING SUPPLY AIR SHALL REMAIN IN ALL AREAS EXCEPT WHERE SHOWN.
- (9) EXISTING CEILING RETURN AIR GRILLE SHALL REMAIN.
- (10) EXISTING WASHERS SHALL REMAIN.
- REMOVE EXISTING WATER PIPING,
 HOSES, PRV VALVE, SHUT-OFF VALVES
 ETC. CAP ABOVE DRYER NEXT TO
 WALL.
- REMOVE EXISTING CLOSET WALL, DOORS, RODS ETC.
- (13) EXISTING FIRE SPRINKLER HEAD SHALL REMAIN.
- (14) EXISTING SMOKE DETECTOR SHALL REMAIN.
- (15) SUNSET ONLY.
- (16) QUAILRUN ONLY.
- (17) REMOVE FLOORING. SEE ARCH SHEET FOR DESCRIPTION.
- (18) EXISTING FLOOR TO REMAIN IN BEDROOM. SEE ARCH SHEET FOR NEW WALL LOCATION.
- REMOVE EXISTING MASONRY WALL FOR NEW DOUBLE DOORS. PROVIDE STEEL ANGLE LINTEL AT NEW DOOR OPENING.

GENERAL NOTE:

- PHASE ONE BUILDING DEMOLITION AND REMODEL TO BE COMPLETE BEFORE MOVING ONTO THE NEXT. ONLY ONE BUILDING IS TO BE WITHOUT DRYERS AT ONE TIME.
- . THIS PAGE CONSISTS OF 3 PROJECTS IN 3 SEPARATE BUILDINGS.



WHW ENGINEERING INC.

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PROJECT NAME & ADDRESS

UTAH STATE
DEVELOPMENT
CENTER DRYER
RELOCATION

DFCM# 08311410

AMERICAN FORK, UTAH

MARK	DATE	REVISION
PROJECT	MANAGI SLW	ER:
DRAWN	BY: STAFI	7
CHECKE S	D BY:	
DATE:	2/12/08	3
WHW JO		
SHEET T		
0,	AKRID	GE AND QUAILRUN

AKRIDGE AND QUAILRUN MECHANICAL PLAN

SHEET NO.

MD101


SUNSET DEMO PLAN

SCALE: 1/4" = 1'-0"

OUTSIDE

QUAILRUN DEMO PLAN

SCALE: 1/4" = 1'-0"

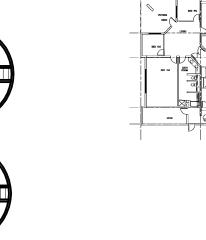


COMMON AREA

TYPICAL KEY PLAN

OAKRIDGE DEMO PLAN

SCALE: 1/4" = 1'-0"

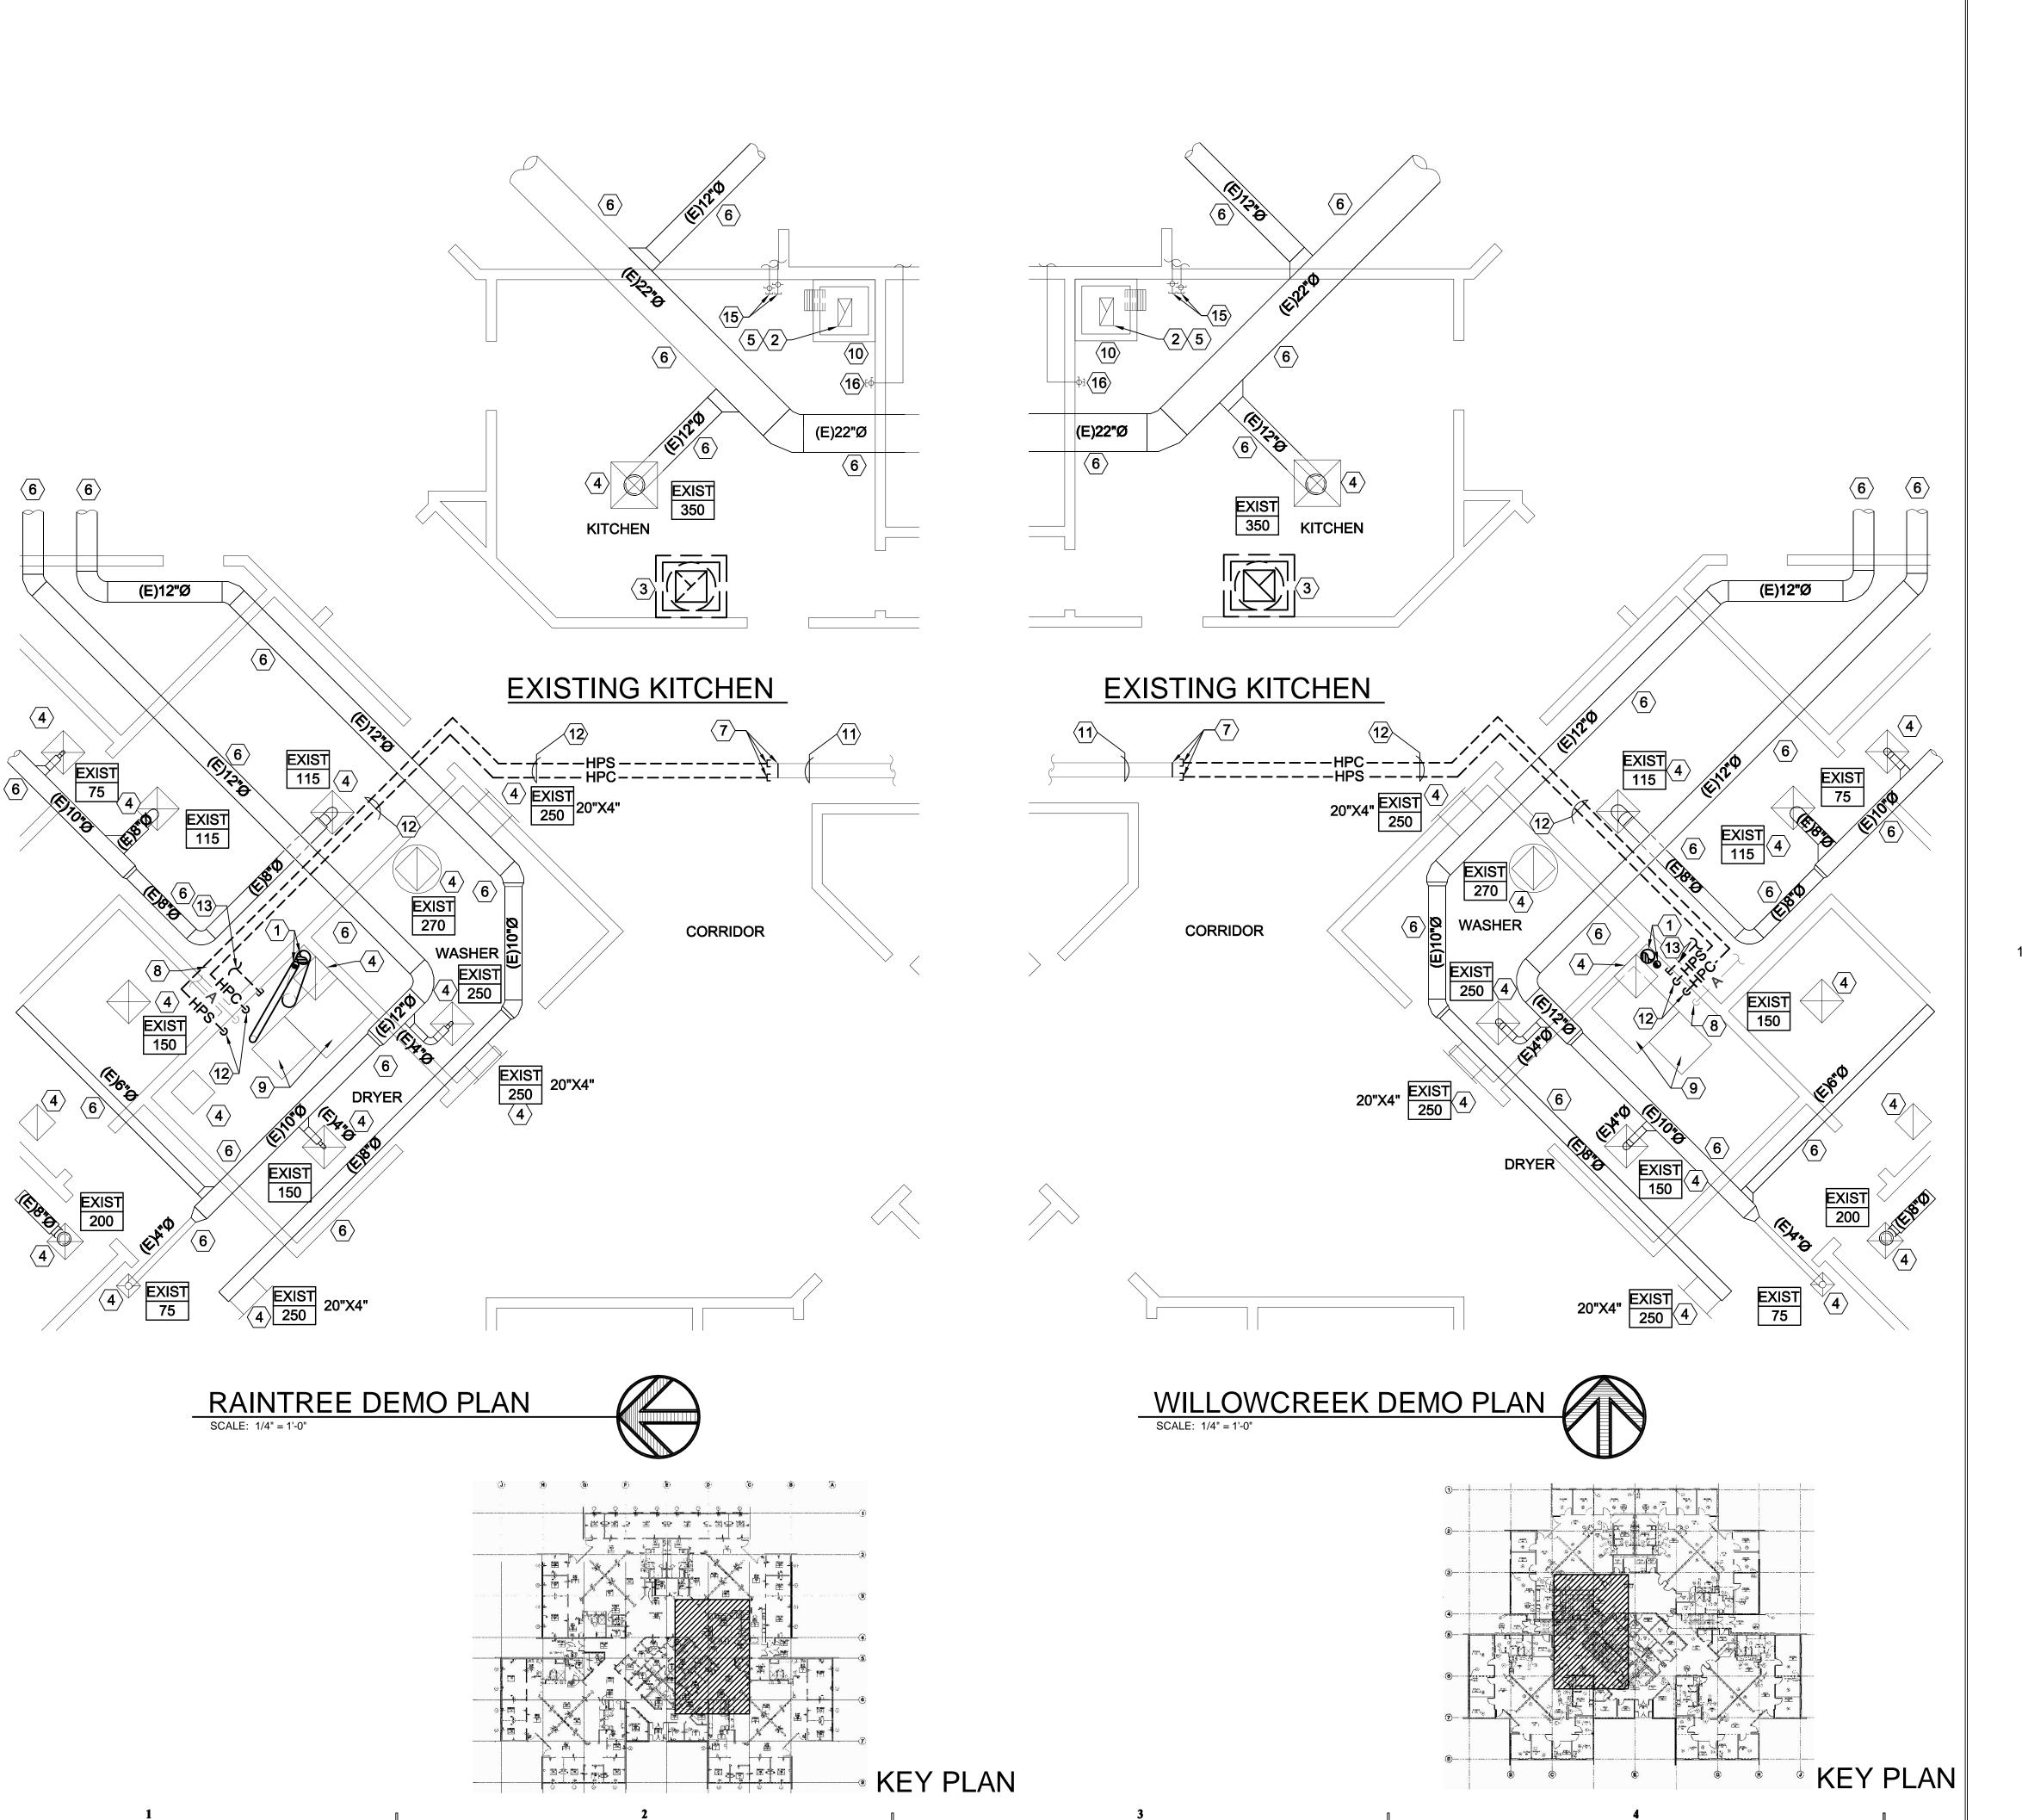

SHEET NOTES

- 1 REMOVE EXISTING DRYER VENTS TO A POINT JUST UNDER ROOF. VENT PIPING AND PENETRATIONS THRU ROOF SHALL REMAIN. CAP VENT BELOW AND ABOVE ROOF.
- 2 EXHAUST DUCT SHALL REMAIN.
 REMOVE EXHAUST FAN. SALVAGE TO
 OWNER IF REQUIRED. PATCH ROOF.
- REMOVE RANGE HOOD, DUCT AND EXHAUST FAN. SALVAGE TO OWNER, IF REQUIRED. PROVIDE SHEET METAL CAP AND R-30 BATT INSULATION ON EXISTING ROOF CURB. PREFINISHED SHEET METAL CAP TO MATCH EXISTING ROOF.
- 4 EXISTING DIFFUSERS, GRILLES ETC. SHALL REMAIN.
- REMOVE EXISTING EXHAUST FAN.
 RE-USE EXISTING CURB IF COMPATIBLE
 OR PROVIDE NEW CURB FOR NEW FAN.
 FIELD VERIFY.
- 6 EXISTING DUCT SHALL REMAIN. FIELD VERIFY LOCATION.
- 7 CAP EXISTING STEAM AND CONDENSATE PIPING. PROVIDE NEW END OF MAIN F & T TRAP. SEE DETAIL.
- 8 CAP EXISTING COMPRESSED AIR PIPING.
- PREMOVE EXISTING DRYERS AND RELOCATE TO NEW LOCATION SHOWN ON SHEET ME101.
- (10) EXISTING STAINLESS STEEL CANOPY SHALL REMAIN.
- (11) EXISTING 1-1/4" HPS AND HPR SHALL REMAIN.
- REMOVE EXISTING 1-1/4" HPS, PIPING, VALVES, HOSES, HANGERS, ETC.
- REMOVE EXISTING WATER PIPING, VALVES, HOSES, HANGERS, ETC. CAP AT WALL PENETRATIONS.
- $\langle 14 \rangle$ EXISTING FLOOR SINK SHALL REMAIN.
- (15) EXISTING CULINARY HOT AND COLD WATER PIPING SHALL REMAIN.
- (16) EXISTING CULINARY COLD WATER PIPING SHALL REMAIN.

GENERAL NOTE:

PHASE ONE BUILDING DEMOLITION AND REMODEL TO BE COMPLETE BEFORE MOVING ONTO THE NEXT. ONLY ONE BUILDING IS TO BE WITHOUT DRYERS AT ONE TIME.



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PROJECT NAME & ADDRESS

UTAH STATE
DEVELOPMENT
CENTER DRYER
RELOCATION

AMERICAN FORK, UTAH


DFCM# 08311410

PROJECT MANAGER:
SLW
DRAWN BY:
STAFF
CHECKED BY:
SLW
DATE:
12/12/08
WHW JOB NO.:
06039
SHEET TITLE

RAINTREE AND WILLOW CREEK MECHANICAL PLAN

SHEET NO.

MD102

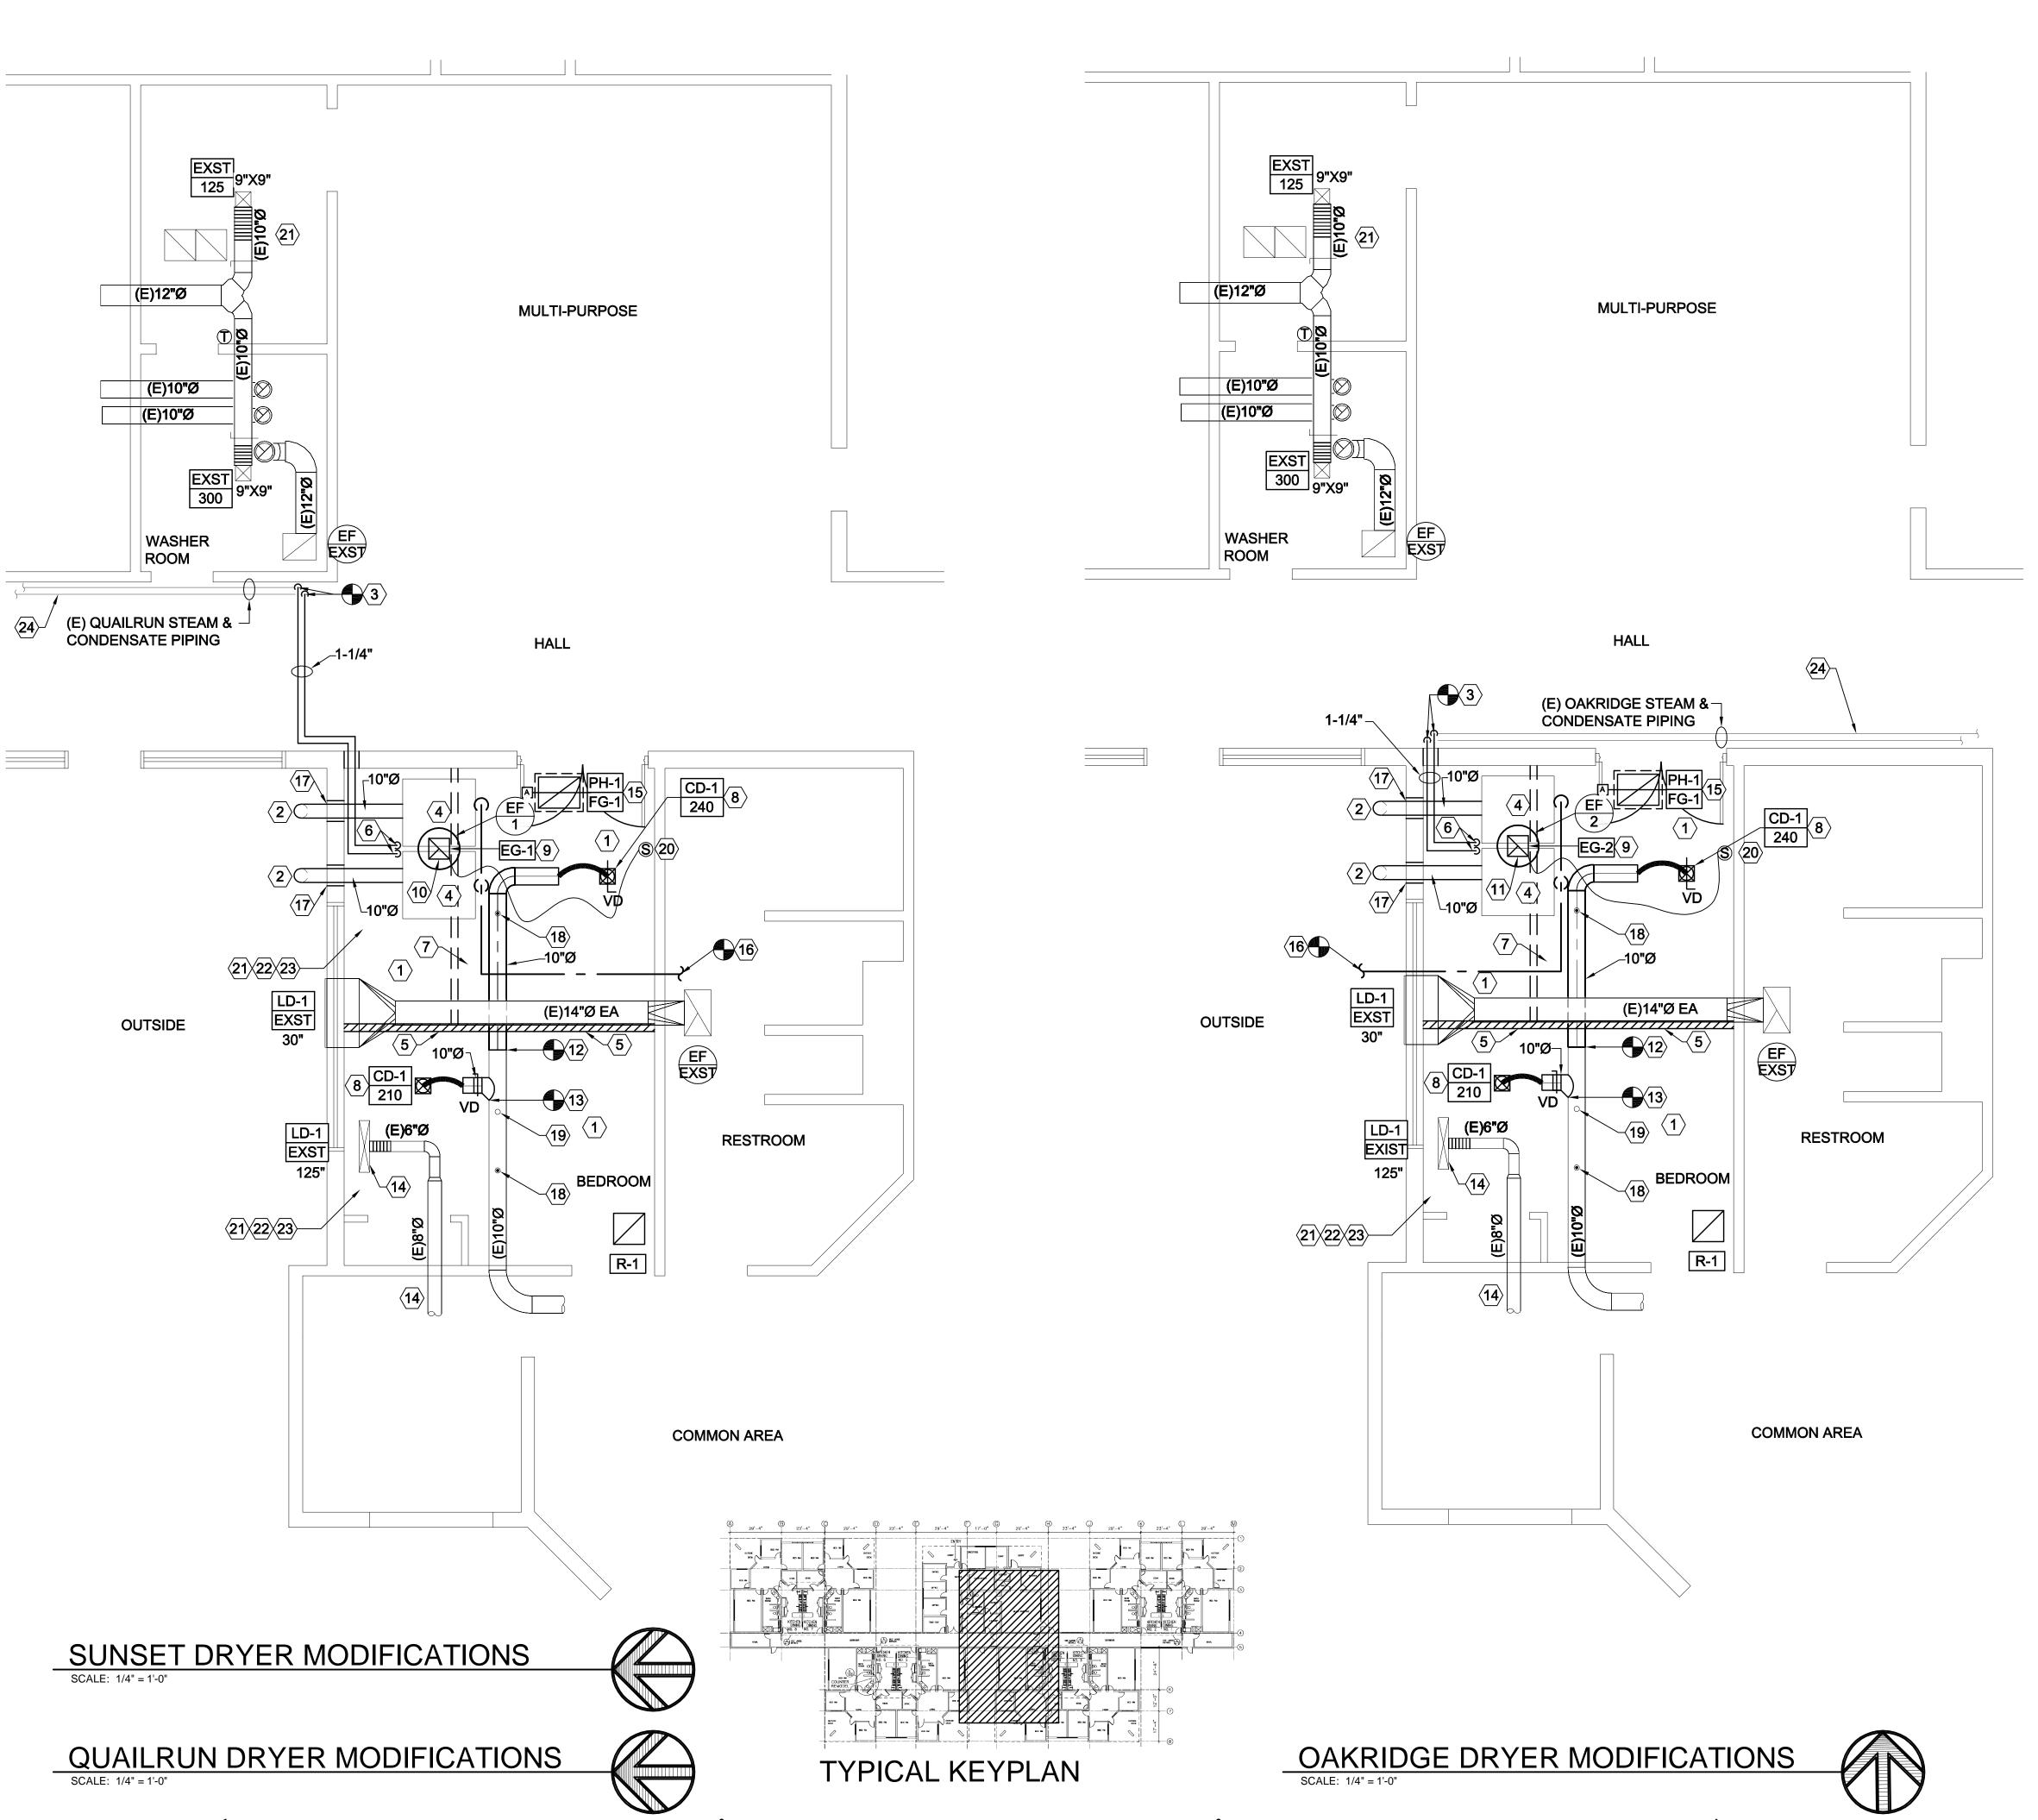

3

SHEET NOTES

- 1 RELOCATE FIRE SPRINKLER HEADS AND DETECTORS AS REQUIRED TO ADEQUATELY PROTECT SPACE.
- 2 ROUTE NEW 10"Ø DRYER EXHAUST VENTS THROUGH SIDEWALL TO OUTSIDE. SEE PHOTO C1/ME501 AND DETAIL C3/ME501.
- TIE INTO EXISTING STEAM PIPING IN HALL ROUTE NEW 1-1/4" HPS AND HPC TO NEW DRYER LOCATION AS SHOWN. TAKE OFF FROM TOP OR FROM TOP 45° OF PIPING.
- (4) RELOCATE EXISTING DRYERS TO NEW LOCATION SHOWN.
- (5) NEW WALL PROVIDED BY G.C. COORDINATE WITH ARCHITECTURAL PLANS AND BUILDING OWNER.
- (6) SEE DETAIL B4/ME501 FOR STEAM CONNECTION TO DRYERS.
- 7 PROVIDE 4" STUD WALL AND FASCIA. SEE DETAIL B3/ME501
- 8 NEW CEILING DIFFUSERS, COORDINATE LOCATION WITH LIGHTS.
- 9 NEW EXHAUST GRILLE CENTERED ABOVE DRYERS.
- 10x8 OR 10"Ø EXHAUST DUCT RISER TO NEW EXHAUST FAN EF-1 ON ROOF.
- (11) 10x8 OR 10"Ø EXHAUST DUCT RISER TO NEW EXHAUST FAN EF-2 ON ROOF.
- (12) CONNECT TO EXISTING 10"Ø. DUCT AT THIS APPROXIMATE LOCATION. FIELD VERIFY EXACT LOCATION.
- (13) CONNECT NEW 9" DUCT INTO EXISTING 10"Ø
 DUCT IN THIS APPROXIMATE LOCATION. FIELD
 VERIFY EXACT LOCATION. SEE DETAIL A1/ME501.
- (14) EXISTING DUCT AND LINEAR DIFFUSER FROM FAN COIL UNIT SHALL REMAIN.
- (15) 24x18 FRESH AIR GRILLE AND AUTO-DAMPER (ELECTRIC) FROM FRESH AIR PENTHOUSE PH-1 ON ROOF. WHEN DRYERS ARE OPERATING DAMPERS ARE OPEN. WHEN DRYERS ARE OFF DAMPERS SHALL CLOSE.
- PROVIDE COLD WATER LINE TO DRYER FIRE SUPPRESSION. SEE DETAIL ME501. FIELD VERIFY LOCATION OF EXISTING CW LINE.
- (17) CORE DRILL THROUGH EXISTING WALL.
 PROVIDE OPENING 2" LARGER IN DIAMETER
 THAN THE 10"Ø VENT. SEAL AIR AND WATER
 TIGHT.
- (18) EXISTING FIRE SPRINKLER HEAD SHALL REMAIN.
- (19) EXISTING SMOKE DETECTOR SHALL REMAIN.
- PROVIDE SPEED CONTROL DIAL FOR NEW EXHAUST FAN. COORDINATE WITH USER FOR EXACT LOCATION.
- (21) COORDINATE WITH G.C. TO PATCH/REPAIR CEILING AND WALLS AS NECESSARY.
- COORDINATE WITH DESIGN BUILD ELECTRICIAN TO REPLACE LIGHTS, RELOCATE, AND PROVIDE NEW AS NECESSARY IN RENOVATED ROOMS THIS AREA. DESIGN BUILD ELECTRICIAN SHALL ALSO PROVIDE NEW SMOKE DETECTOR IN NEW LAUNDRY ROOM, AND VERIFY PROPER OPERATION OF EXISTING DETECTOR IN BEDROOM. NECESSARY.
- COORDINATE WITH FIRE SPRINKLER
 CONTRACTOR TO PROVIDE NEW SPRINKLER
 LAYOUT IN REMODELED ROOMS. SEE SECTION
 15300. TIE NEW HEADS INTO EXISTING SYSTEM.
- PROVIDE NEW 2" EXPANSION JOINTS IN EXISTING STEAM AND CONDENSATE PIPING IN HALL. PROVIDE TRANSITIONS TO EXISTING PIPING AS NECESSARY. LOCATE NEW JOINTS IN MIDDLE OF HALLWAY AND PROVIDE ANCHORS TO WALL AT EACH END. PROVIDE GUIDES UP STREAM AND DOWN STREAM OF NEW EXPANSION JOINTS, PER JOINT MANUFACTURERS RECOMMENDATIONS.

GENERAL NOTE:

THIS PAGE CONSISTS OF 3 PROJECTS IN 3 SEPARATE BUILDINGS.



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PROJECT NAME & ADDRESS

UTAH STATE DEVELOPMENT CENTER DRYER RELOCATION

REVISION

DFCM# 08311410

AMERICAN FORK, UTAH


MARK DATE

PROJECT MANAGER: SLW	
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CHECKED BY: SLW	
DATE: 12/12/08	
WHW JOB NO.: 06039	
SHEET TITLE	
	DRAWN BY: STAFF CHECKED BY: SLW DATE: 12/12/08 WHW JOB NO.: 06039

OAKRIDGE AND QUAILRUN MECHANICAL PLAN

SHEET NO.

ME101

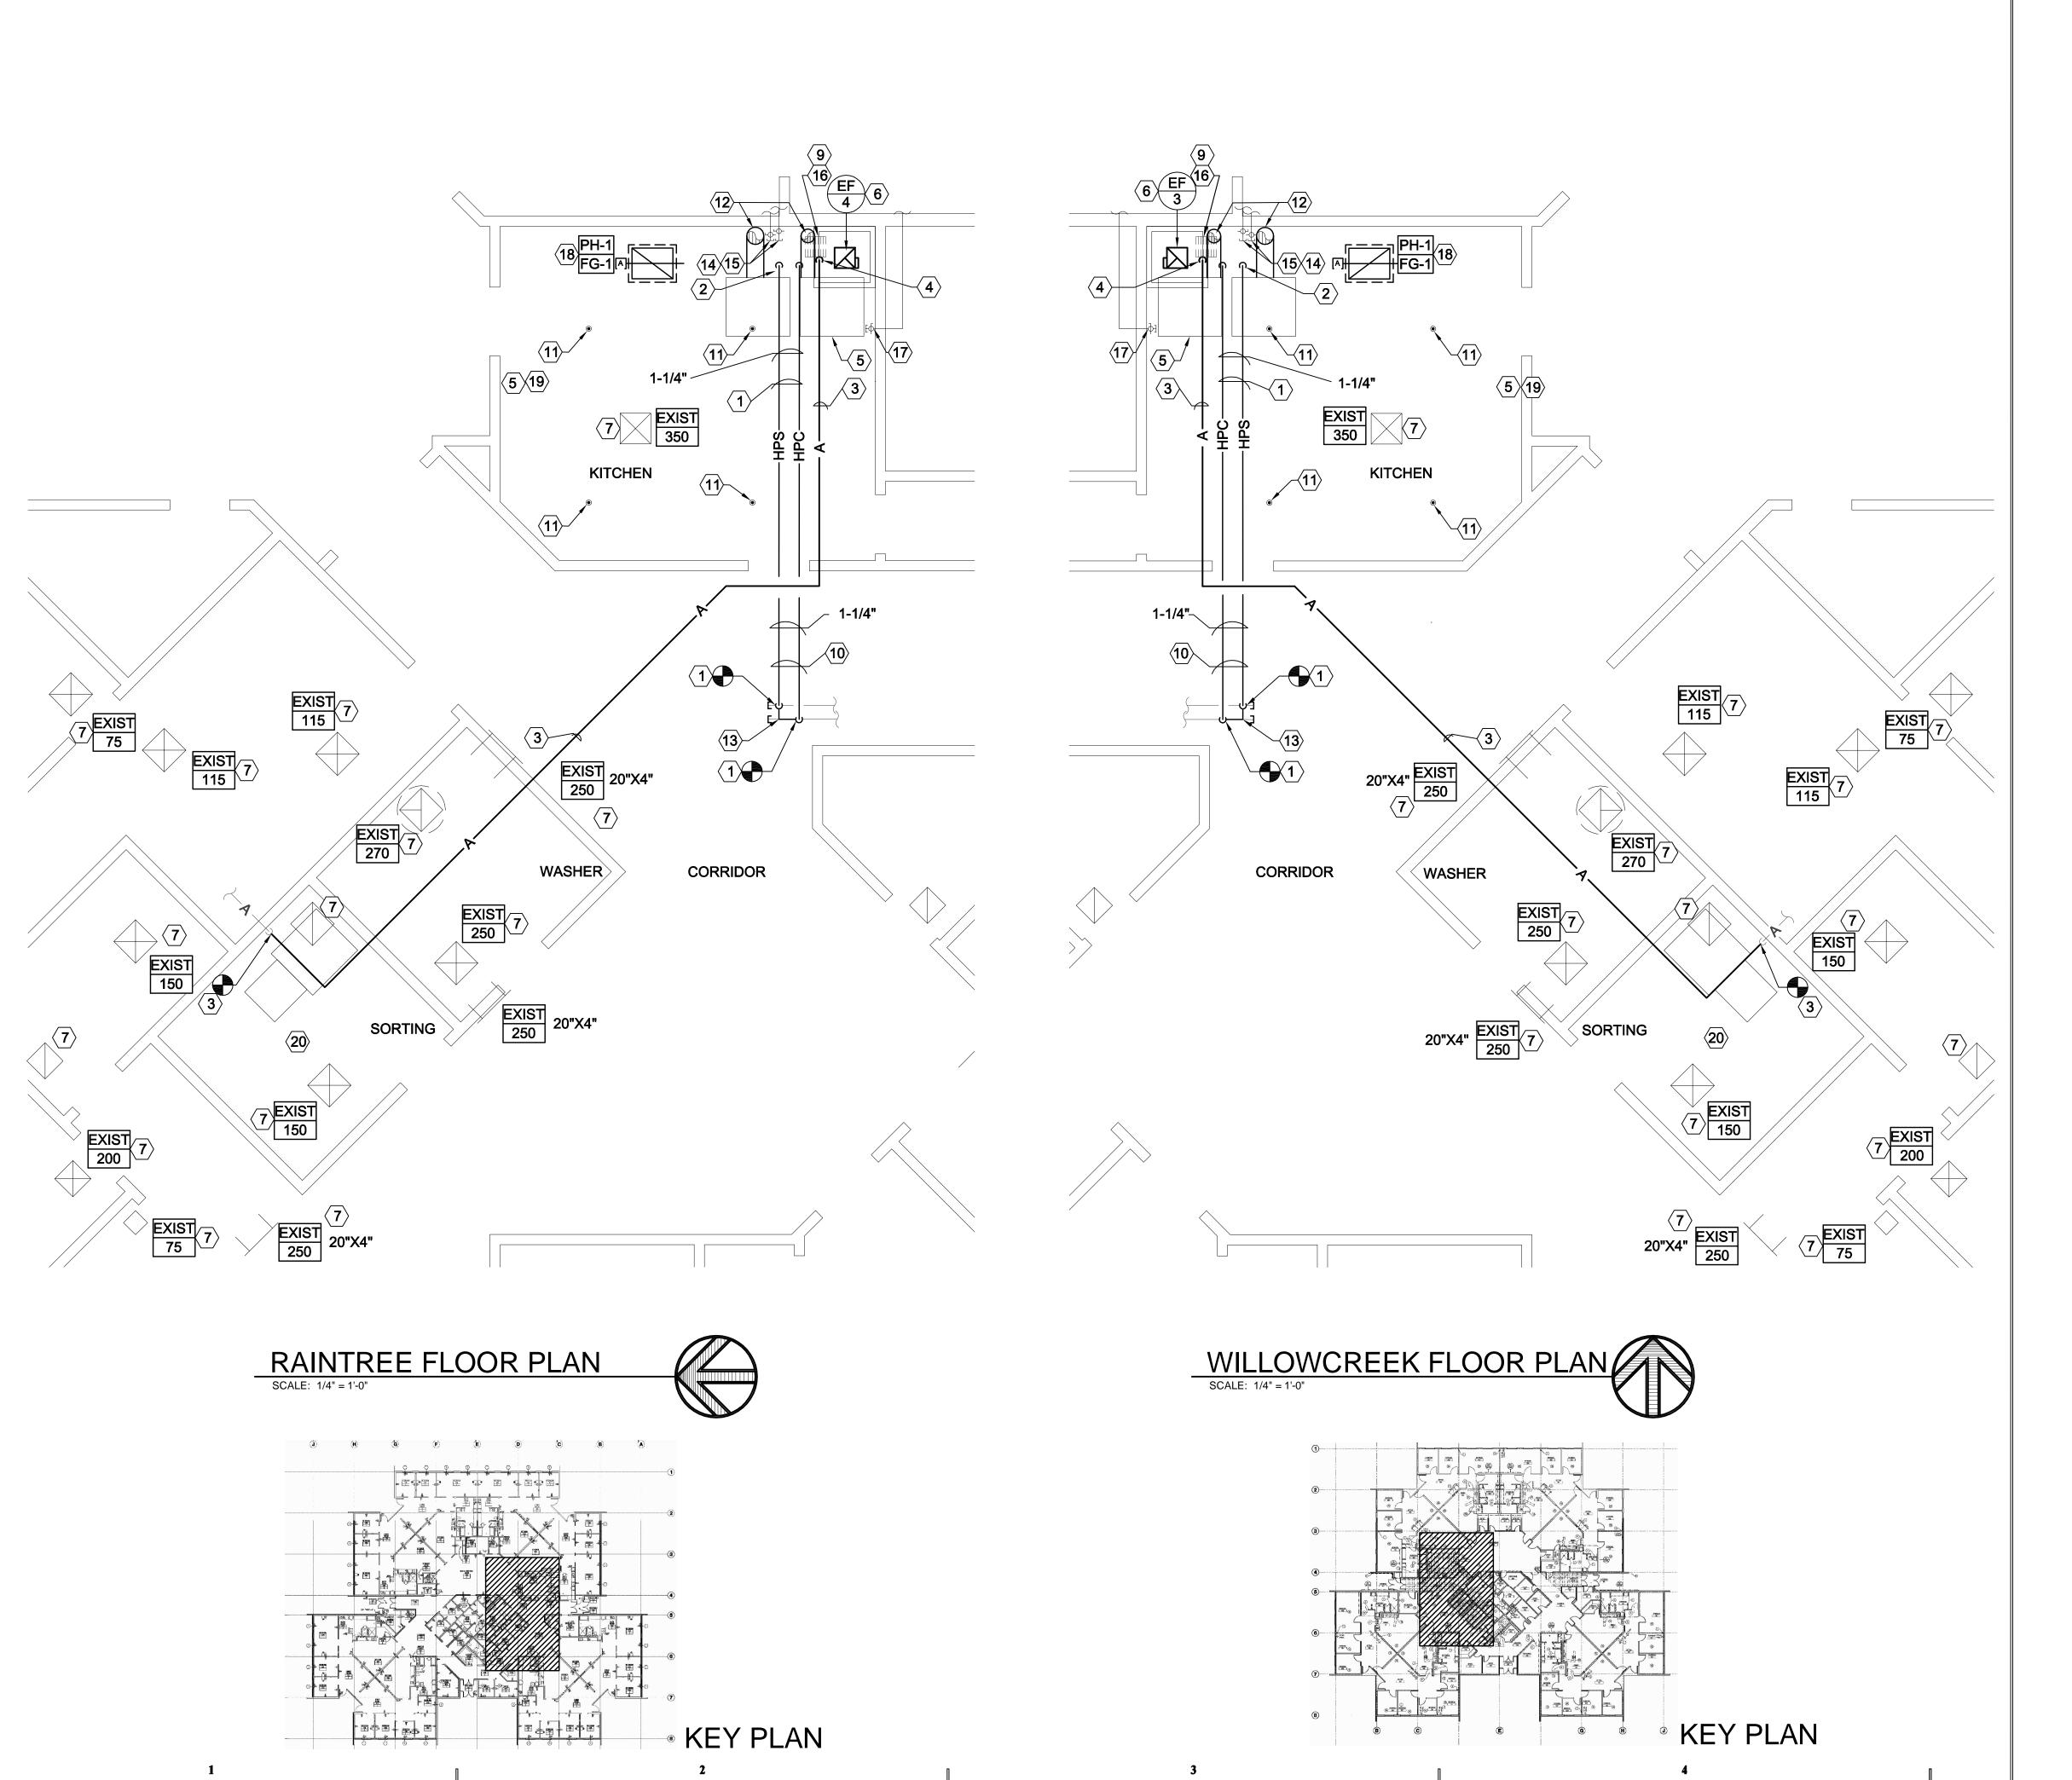

3

SHEET NOTES

- CONNECT NEW HPS AND HPR TO EXISTING AT THIS LOCATION AND EXTEND OVERHEAD TO RELOCATED DRYERS. FIELD VERIFY LOCATION OF EXISTING PIPING.
- SEE DETAIL A4/ME501 FOR STEAM CONNECTION TO RELOCATED DRYERS.
- CONNECT NEW COMPRESSED AIR LINE TO EXISTING AND EXTEND OVERHEAD TO RELOCATED DRYERS. FIELD VERIFY DROUTING.
- 4 SEE DETAIL A4/ME501 FOR COMPRESSED AIR CONNECTION.
- 5 LOCATE EXISTING DRYERS AT EXISTING KITCHEN HOOD WHERE POSSIBLE..
- PROVIDE NEW EXHAUST FAN ON ROOF.
 USE EXISTING ROOF CURB IF
 POSSIBLE. IF EXISTING ROOF CURB
 CANNOT BE REUSED, REMOVE AND
 PROVIDE NEW CURB USING EXISTING
 ROOF OPENING. RE-USE EXISTING
 DUCT AND CANOPY.
- 7 EXISTING CEILING DIFFUSER AND RETURN, SUPPLY AND EXHAUST GRILLE SHALL REMAIN.
- WILLOW CREEK AND RAINTREE ARE MIRROR IMAGES OF EACH OTHER. FIELD VERIFY ALL CONDITIONS AND LOCATIONS OF EXISTING PIPING, FIRE SPRINKLER PIPING, HEADS, LIGHTS, FLOOR SINKS ETC.
- 9 IF EXISTING FLOOR SINKS ARE IN THE WAY OF LOCATING THE DRYERS, CONTRACTOR SHALL FILL SINK WITH CONCRETE EVEN WITH EXISTING FLOOR.
- IF THE ONLY ROUTING OF PIPING IS IN THE CORRIDOR PIPING SHALL BE ROUTED AS HIGH AS POSSIBLE AND INSULATION PAINTED THE SAME COLOR AS THE CORRIDOR CEILING.
- (11) FIRE SPRINKLER HEADS SHALL REMAIN.
- (12) EXTEND 10"Ø DRYER VENT UP TO ROOF. SEE DETAIL C3/ME501.
- CUT EXISTING STEAM AND
 CONDENSATE PIPING AND MAKE NEW
 CONNECTIONS AT THIS APPROXIMATE
 LOCATION. PROVIDE END OF MAIN
 TRAP. SEE DETAIL C4/ME501.
- CONNECT TO EXISTING COLD WATER PIPING. EXTEND TO FIRE SUPPRESSION CONNECTION ON DRYER. PROVIDE WITH NEW PRV VALVE, 25 75 PSIG.
- (15) EXISTING CULINARY HOT AND COLD WATER PIPING SHALL REMAIN.
- water piping shall remain.

 (16) EXISTING FLOOR SINK SHALL REMAIN.

 B
- (17) EXISTING CULINARY COLD WATER PIPING SHALL REMAIN.
- 24x18 FRESH AIR GRILLE AND
 AUTO-DAMPER (ELECTRIC) FROM
 FRESH AIR PENTHOUSE PH-1 ON ROOF.
 WHEN DRYERS ARE OPERATING
 DAMPERS ARE OPEN. WHEN DRYERS
 ARE OFF DAMPERS SHALL CLOSE.
- PROVIDE SPEED CONTROL DIAL FOR NEW EXHAUST FAN. COORDINATE WITH USER FOR EXACT LOCATION.
- COORDINATE WITH G.C. TO PATCH/REPAIR CEILING AND WALLS AS NECESSARY.



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UTAH STATE
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CENTER DRYER
RELOCATION

AMERICAN FORK, UTAH

DFCM# 08311410

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ME102



- END OF STEAM MAIN SIZE AS SHOWN ON DRAWINGS VERTICAL DUCTING HORIZONTAL DUCTING UNION FLOAT & THERMOSTATIC TRAP 3/4" CORE DRILL THROUGH -8" MINIMUM EXISTING BLOCK WALL. REMOVABLE CAP 4" LONG NIPPLE FOR CLEANING AND CAP **STRAINER** - CONDENSATE RETURN TO TURNED ON RECEIVER SEE DRAWINGS BALL VALVE SIDE FOR CONTINUATION. SCALE POCKET - FULL
SIZE OF STEAM MAIN 20" MIN. CLEARANCE 20" MIN. CLEARANCE END OF MAIN OR RISE **OPENING MUST BE 2" INCHES** LARGER THAN DUCT (ALL THE

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& DRIP CONNECTION DETAIL SCALE: NONE

> -PENTHOUSE AIR INTAKE **ROOF CURB BUILT-UP-**- ROOF STRUCTURE **AUTO DAMPER**

PENTHOUSE DETAIL -NEW PRV (25 - 75) PSI **NEW ISOLATION -**BALL VALVE /-3/4 HOSE CONNECTION

> DRYER FIRE SUPPRESSION CONNECTION DETAIL SCALE: NONE

UTAH STATE **DEVELOPMENT CENTER DRYER** RELOCATION DFCM# 08311410

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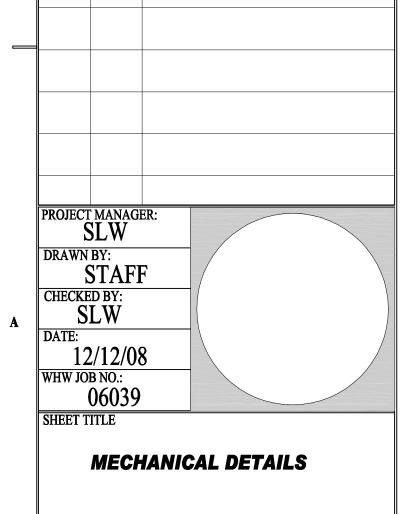
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AMERICAN FORK, UTAH


REVISION

MARK DATE



ME501

EXTERIOR PHOTO OF OAKRIDGE NEW DRYER LOCATION

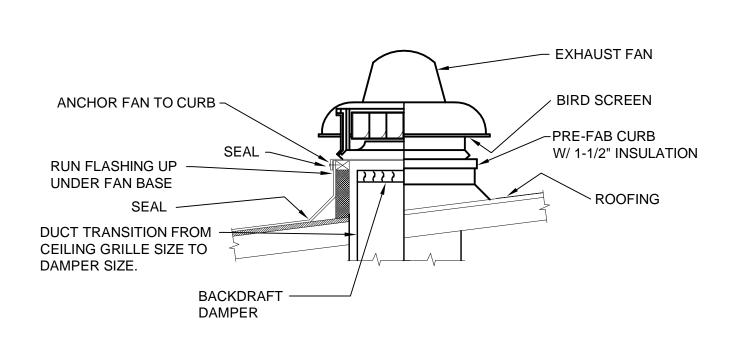

RAINTREE \mid WILLOW CREEK \mid TO ROOF OR WALL \longrightarrow TRANSITION TO -DRYER OUTLET FIELD VERIFY 10"Ø DRYER REMOVABLE CAP FOR CLEANING

WAY AROUND). THE DUCT MUST

OPENING AIR AND WATER TIGHT.

DRYER VENTING DETAIL

BE CENTERED WITHIN THIS

OPENING. SEAL AROUND


SCALE: NONE

ROOF MOUNTED EXHAUST FAN DETAIL

SCALE: NONE

B2

VERTICAL DRYER VENT DETAIL

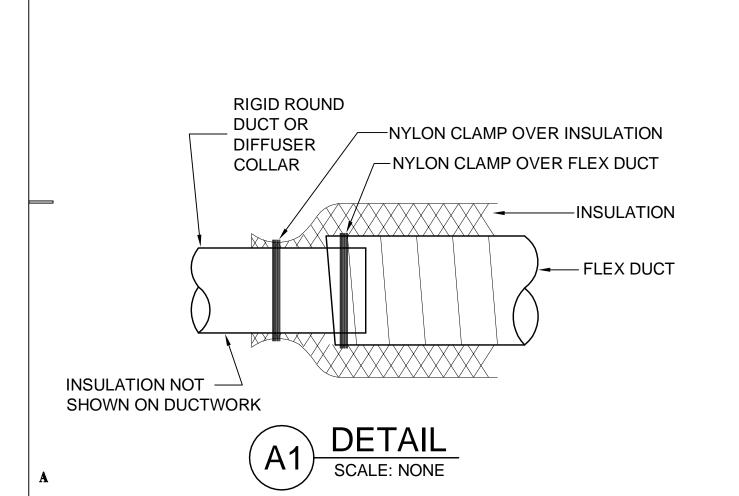

— SEAL SEAM WITH ® HARD-CAST DUCT SEALER #10x3/4" SHEET METAL — SCREWS SIZE CUT OUT ACCORDING -- 22 GA. BLADE TO MANUFACTURERS -NEOPRENE BUSHING RECOMMENDATIONS. EACH END -3/8" SQUARE ROD -22GA. RIGID SHEET METAL WRAPPED WITH INSULATION. SEE DETAIL **INSULATION NOT** SHOWN SEE **SPECIFICATIONS** LOCKING QUADRANT HANDLE OR REMOTE **CEILING OPERATOR** WHERE DAMPER **BRANCH** IS INACCESSIBLE. DUCT (TYP.) ATTACH FLEXIBLE DUCT FASTEN RIGID DUCT TO FITTING W/ #10x3/4" TO END. SEE DETAIL SHEET METAL SCREWS. DO NOT INTERFERE W/ VOLUME DAMPER OPERATION.

ROUND-TO-ROUND **DUCT CONSTRUCTION DETAIL** SCALE: NONE

STEAM COIL - $\langle 2 \rangle$ $\langle 1 \rangle$ UNION - TYPICAL. NEW STEAM -2 STEAM COIL IN DRYER. PIPING 1-1/4" $\langle 3 \rangle$ BUCKET TRAP. 4 1-1/4" STRAINER TURNED ON SIDE. $\overline{\left\langle 5\right\rangle}$ 1-1/4" STEAM HOSE, MINIMUM 24". NEW CONDENSATE -PIPING 1-1/4" $\langle 6 \rangle$ STEAM BALL VALVES 1-1/4". 1" DRYER -CONNECTION $\langle 7 \rangle$ CHECK VALVE 1-1/4". 8 1-1/4"x1" REDUCER. STEAM COIL $\langle 9 \rangle$ FULL LINE SIDE DRIP LEG WITH CAP. $\langle 2 \rangle$ ___ 1" DRYER CONNECTION

> STEAM DRYER SYSTEM DETAIL SCALE: NONE

DIFFUSER SCHEDULE												
SYMBOL	TYPE	MAX CFM	FACE SIZE	NECK SIZE	CEILING TYPE	BLOW	PATTERN	SCHEDULE NOTES				
D-1 CFM	CEILING	250	9/9	8"Ø	HARD	4WAY	4	1,2				

- 1. MAXIMUM NC 25 AT CFM LISTED.
- 2. TRANSITION AS REQUIRED TO DUCT WORK SHOWN ON PLAN.

	REGISTER, LOUVER & GRILLE SCHEDULE													
SYMBOL	TYPE	SERVICE	MAX CFM	NOMINAL SIZE	THROAT SIZE	CEILING TYPE	SCHEDULE NOTES							
R-1	CEILING	RETURN	250	10/10	10/10	HARD	1,2,4							
EG-1	CEILING	EXHAUST	600	14/14	14/14	HARD	1,2,4							
FG-1	CEILING	FRESH AIR	1200	18/24	18/24	HARD	1,2,4							
PH-1	ROOF	FRESH AIR	1200	18/24/15	18/24/15	N/A	3,5,6							

REGISTER. LOUVER AND DIFFUSER SCHEDULE NOTES:

- 1. MAXIMUM NC = 25 @ MAXIMUM CFM NOTED.
- 2. SHALL BE PRICE 535 OR EQUAL BY OTHER APPROVED MANUFACTURERS.
- 3. SHALL BE RUSKIN PH811 OR EQUAL BY OTHER APPROVED MANUFACTURES.
- 4. FINISH SHALL BE OFF-WHITE BAKED ENAMEL.
- 5. PROVIDE WITH BIRD SCREENS.
- 6. FINISH SHALL BE BAKED ENAMEL WITH COLOR BY OWNER.

EXHAUST FAN SCHEDULE												
SYMBOL	MANUFACTURER & MODEL No.	SERVES	C.F.M.	STATIC PRESSURE IN. WG.	MAX NOISE SONES	MOTOR			OPER. WT.	COMMENTS		
						V - Ø - Hz	W	RPM				
EF 1	COOK ACED 100C15DH	DRYER ROOM	500	0.2	7	120/1/60	104	1190	30	1,2,3		
EF 2	COOK ACED 100C15DH	DRYER ROOM	500	0.2	7	120/1/60	104	1190	30	1,2,3		
EF 3	COOK ACED 100C15DH	DRYER ROOM	500	0.2	7	120/1/60	104	1190	30	1,2,3		
EF 4	COOK ACED 100C15DH	DRYER ROOM	500	0.2	7	120/1/60	104	1190	30	1,2,3		
1. PROVIDE FACTORY INSTALLED DISCONNECT.												

- 1. PROVIDE FACTORY INSTALLED DISCONNECT.
- 2. PROVIDE VARIABLE SPEED CONTROL DIAL IN ROOM.
- 3. PROVIDE WITH BACKDRAFT DAMPER AND CURB.



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PROJECT NAME & ADDRESS

UTAH STATE DEVELOPMENT CENTER DRYER RELOCATION

DFCM# 08311410

AMERICAN FORK, UTAH

MARK DATE			REVISION				
PROJECT S	MANAGI LW	ER:					
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MECHANICAL SCHEDULE

ME601